PROPOSED SUBDIVISION

1A FLOWERS DRIVE CATHERINE HILL BAY (HAMLET A)

WALLALONG LAND DEVELOPMENTS PTY LTD

LAKE MACQUARIE CITY COUNCIL

DRAWING SCHEDULE 192							
DWG No.	SHEET TITLE	REV					
C400	COVER SHEET	5					
C401	GENERAL ARRANGEMENT PLAN	3					
C402	PLAN SHEET (1 OF 2)	5					
C403	PLAN SHEET (2 OF 2)	5					
C404	TYPICAL SECTIONS AND NOTES	4					
C405	ROAD 1 LONGITUDINAL SECTION	3					
C406	ROAD 1 CROSS SECTIONS (1 OF 3)	3					
C407	ROAD 1 CROSS SECTIONS (2 OF 3)	4					
C408	ROAD 1 CROSS SECTIONS (3 OF 3)	4					
C409	ROAD 2 LONGITUDINAL SECTION	3					
C410	ROAD 2 CROSS SECTIONS (1 OF 4)	3					
C411	ROAD 2 CROSS SECTIONS (2 OF 4)	3					
C412	ROAD 2 CROSS SECTIONS (3 OF 4)	4					
C413	ROAD 2 CROSS SECTIONS (4 OF 4)	3					
C414	ROAD 3 LONGITUDINAL SECTION	3					
C415	ROAD 3 CROSS SECTIONS (1 OF 2)	3					
C416	ROAD 3 CROSS SECTIONS (2 OF 2)	3					
C417	ROAD 4 LONGITUDINAL SECTION	3					
C418	ROAD 4 CROSS SECTIONS	3					
C419	ROAD 5 LONGITUDINAL SECTION	3					
C420	ROAD 5 CROSS SECTIONS (1 OF 5)	4					
C421	ROAD 5 CROSS SECTIONS (2 OF 5)	4					
C422	ROAD 5 CROSS SECTIONS (3 OF 5)	4					
C423	ROAD 5 CROSS SECTIONS (4 OF 5)	4					
C424	ROAD 5 CROSS SECTIONS (5 OF 5)	4					
C425	SITE REGRADING PLAN (1 OF 2)	3					
C426	SITE REGRADING PLAN (2 OF 2)	3					
C427	SOIL AND WATER MANAGEMENT PLAN (1 OF 2)	4					
C428	SOIL AND WATER MANAGEMENT PLAN (2 OF 2)	4					
C429	SOIL AND WATER MANAGEMENT DETAILS	3					
C430	LANDCOM BLUE BOOK FIGURES (1 OF 2)	3					
C431	LANDCOM BLUE BOOK FIGURES (2 OF 2)	3					





A.B.N. 92 086 017 745 1 HARTLEY DRIVE, THORNTON NSW 2322 PO BOX 3337, THORNTON NSW 2322 PHONE: (02) 4964 1811




LOCALITY PLAN



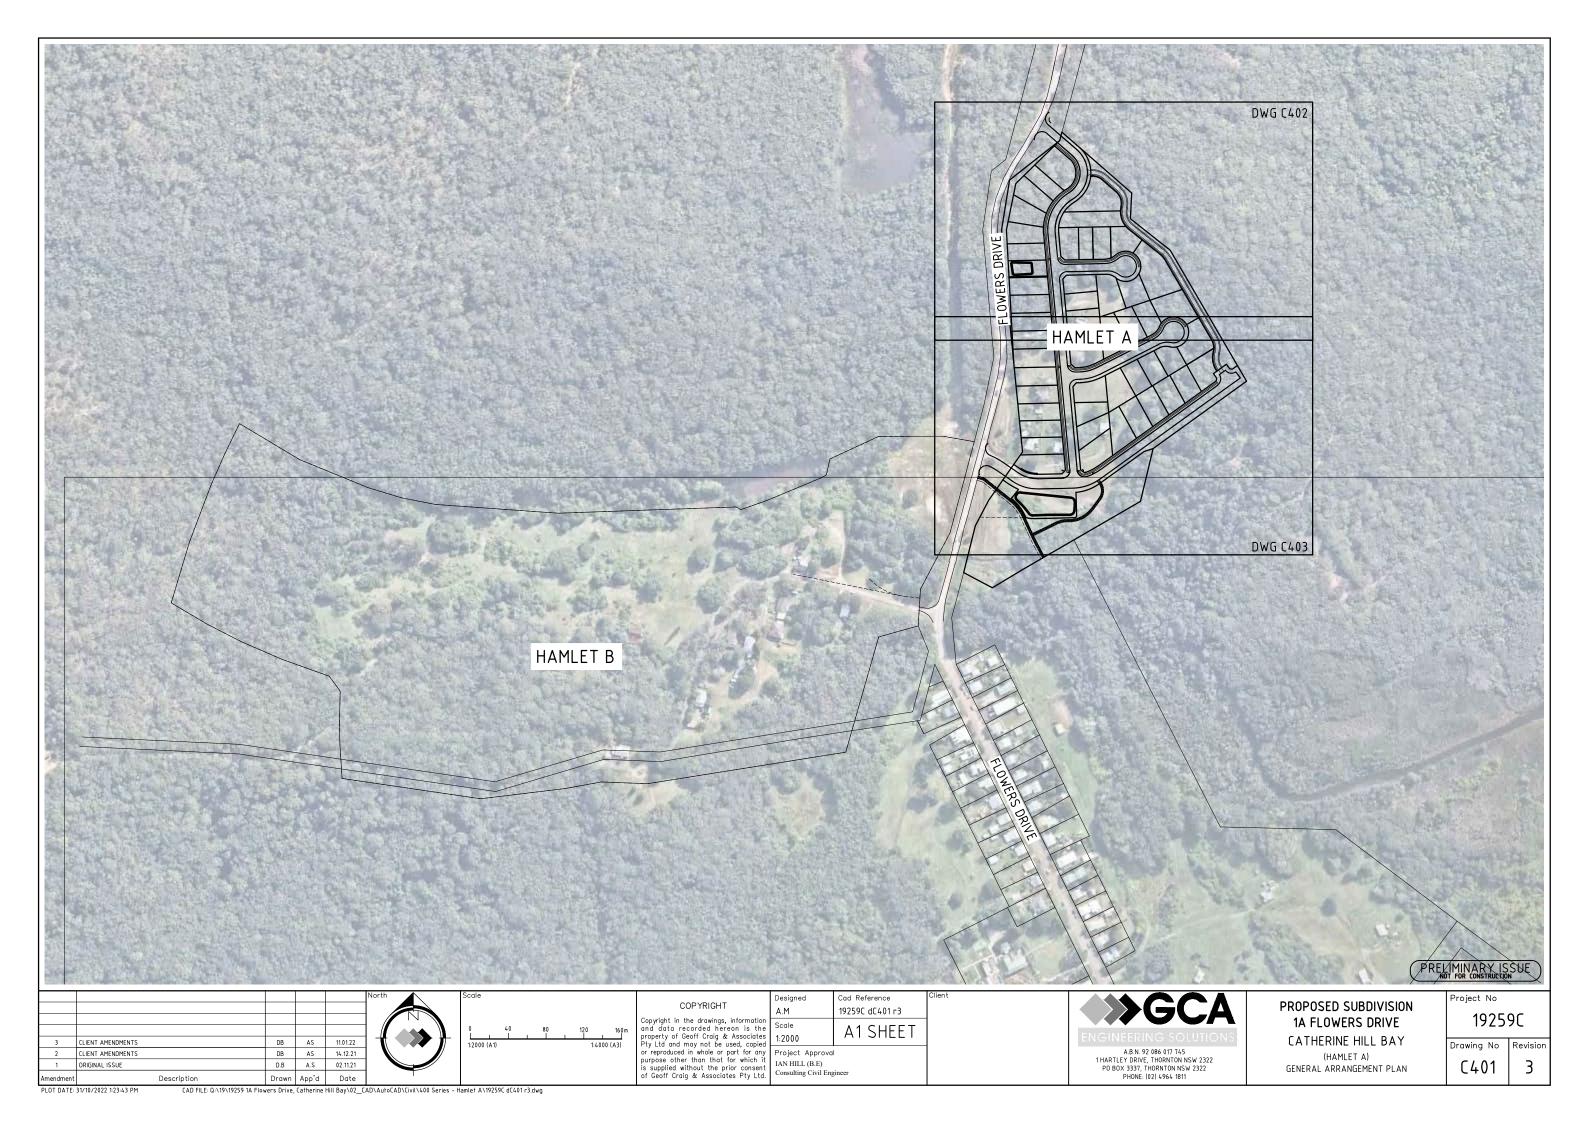

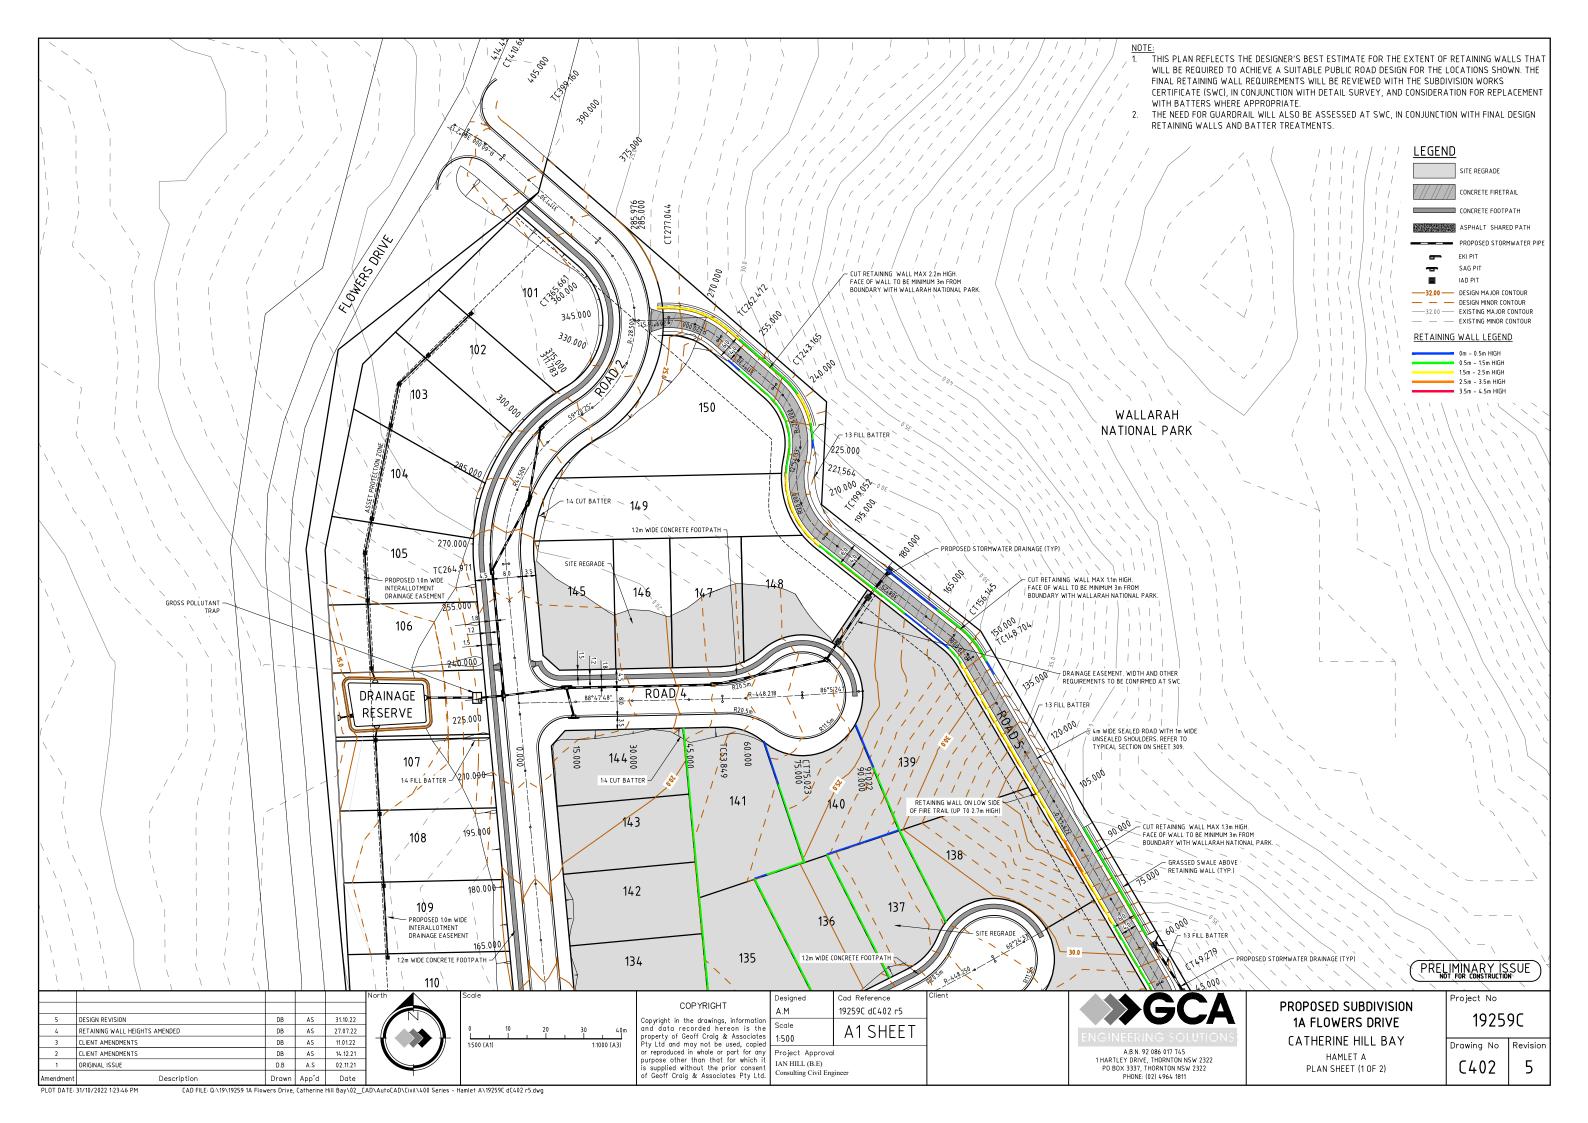

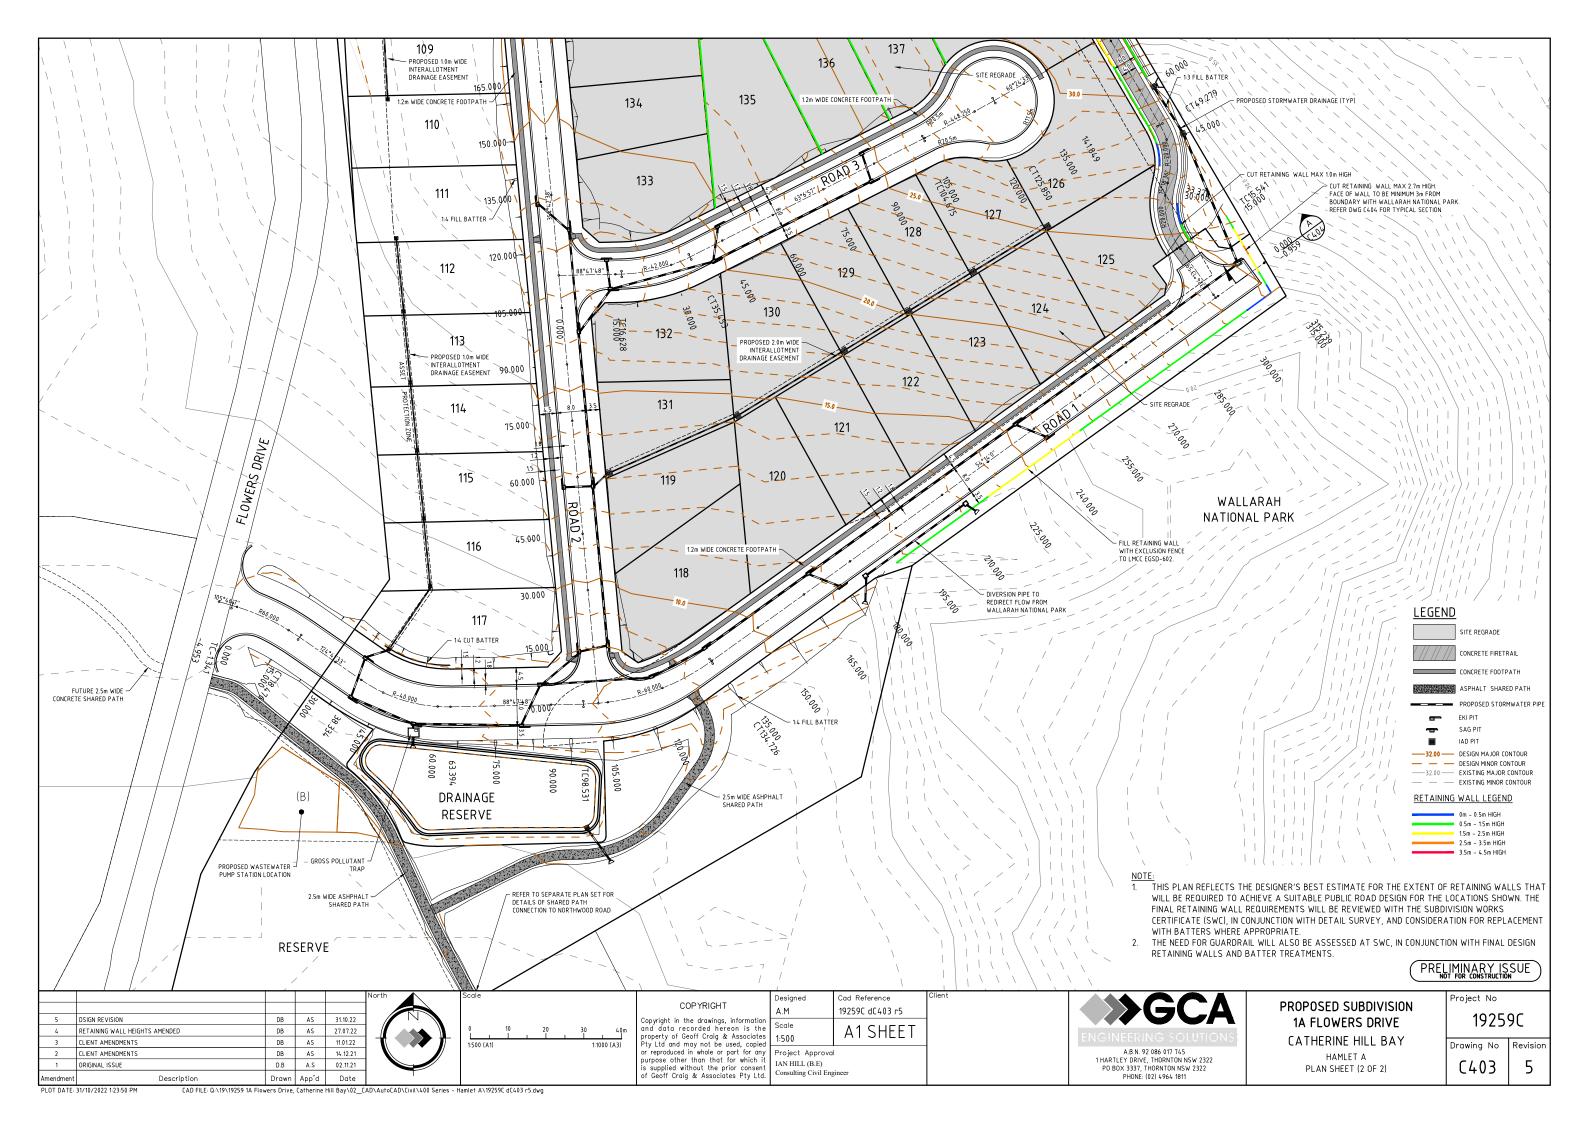

NOTES: 1. ALL DIMENSIONS OF EASEMENTS AND LOTS ARE SUBJECT TO REGISTRATION OF DEPOSITED PLAN. - ROLL KERB & GUTTER IN ROLL KERB & GUTTER IN ACCORDANCE WITH LMCC STD DWG EGSD -101 2. ALL WORK TO BE CARRIED OUT IN ACCORDANCE WITH LMCC ENGINEERING GUIDELINES AND STANDARD DRAWINGS. STD DWG EGSD -101 EROSION CONTROL DEVICES AND SILTATION TRAPS TO BE INSTALLED BEFORE SITE IS DISTURBED IN ACCORDANCE WITH THE ATTACHED SILTATION PLAN. SITE REGRADE SITE REGRADI PROVIDE 1.2m WIDE CONCRETE -4. DENUDED AREAS TO BE STABILISED / RE-VEGETATED ON COMPLETION OF WORKS FOOTPATH IN ACCORDANCE WITH PAVEMENT DESIGN TO BE IN-LMCC STD DWG EGSD-301 5. ALL REINFORCED CONC. STORMWATER DRAINAGE PIPES ARE TO BE RUBBER RING JOINTED PROVIDE SUBSOIL DRAINAGE TO BOTH PROVIDE SUBSOIL DRAINAGE TO BOTH 6. ALL EKI PIT GRATES TO BE HOT DIPPED GALVANISED 80-85 MICRONS THICK. ALL GRATES TO BE PROVIDED WITH HINGE PINS IN ACCORDANCE WITH SIDES OF ROAD TO COUNCIL STANDARD SIDES OF ROAD TO COUNCI TYPICAL SECTION - ROAD 3 & 4 DETAILS. REFER TO GEOTECHNICAL REPORT STANDARD DETAILS. REFER TO GEOTECHNICAL REPORT SCALE 1:50 ALL PITS DEEPER THAN 1.2m ARE TO BE CONSTRUCTED WITH STEP IRONS IN ACCORDANCE WITH AS 1657-1992. 8. SIDE WALLS OF ALL PITS GREATER THAN 1.5m DEEP TO HAVE SL82 MESH CENTRALLY PLACED FOR FULL DEPTH WITH N12 "L" CORNER BARS (450 LEGS) @ 400 CTS. 4.00m 4.00m ALL INTERALLOTMENT DRAINAGE PIPES TO BE SEWER GRADE uPVC (UNLESS OTHERWISE SHOWN) OR AN APPROVED EQUIVALENT. THE MINIMUM SLOPE OF INTERALLOTMENT DRAINAGE LINE SHALL BE 1%, THE INTERALLOTMENT DRAINAGE LINE SHALL BE A MINIMUM OF 0.5m FROM THE BOUNDARY AND LOCATED IN AN EASEMENT 2.0m WIDE. - ROLL KERB & GUTTER IN ROLL KERB & GUTTER IN-ACCORDANCE WITH LMCC ACCORDANCE WITH LMCC STD DWG EGSD -101 STD DWG EGSD -101 5% SITE REGRADE 2.5% 10. ALL INTERALLOTMENT DRAINAGE PITS ARE TO BE CONSTRUCTED IN ACCORDANCE WITH LMCC STD DWG EGSD-402. 11. ALL EXISTING UNDERGROUND SERVICES MUST BE LOCATED AND EXPOSED PRIOR TO EARTHWORKS COMMENCING AND IT IS THE RESPONSIBILITY PROVIDE 1.2m WIDE CONCRETE -OF THOSE PERSONS USING THIS PLAN TO CONFIRM BOTH POSITION & LEVEL OF THESE UTILITIES IN CONJUNCTION WITH THE APPROPRIATE FOOTPATH IN ACCORDANCE WITH PAVEMENT DESIGN TO BE IN-ACCORDANCE WITH THE GEOTECHNICAL REPORT PROVIDE SUBSOIL DRAINAGE TO BOTH PROVIDE SUBSOIL DRAINAGE TO BOT 12. SUBSOIL DRAINS ARE TO BE PROVIDED TO COUNCIL INSPECTOR'S REQUIREMENTS. FLUSH POINTS TO BE PROVIDED AT MAXIMUM 60.0m INTERVALS. SIDES OF ROAD TO COUNCIL STANDARD TYPICAL SECTION - ROAD 2 SIDES OF ROAD TO COUNCIL DETAILS, REFER TO GEOTECHNICAL REPORT 13. PAVEMENT THICKNESS TO BE IN ACCORDANCE WITH THE RECOMMENDATIONS OF THE GEOTECHNICAL REPORT. STANDARD DETAILS, REFER TO SCALE 1:50 GEOTECHNICAL REPORT 14. WORKING HOURS ON SITE SHALL BE IN ACCORDANCE WITH EPA & COUNCIL REQUIREMENTS. 15. VEHICULAR ACCESS AND ALL SERVICES ARE TO BE MAINTAINED AT ALL TIMES TO ADJOINING PROPERTIES AFFECTED BY CONSTRUCTION WORKS. 4 00m - FXCLUSION FENCING IN FRONT OF WALL 16 MAINTENANCE ON THE SEEDED AND TUREED AREAS SHALL BE OVER A 3 MONTH PERIOD. TURE THE FULL WIDTH OF ALL FARTH DISH DRAINS LAY - ROLL KERB & GUTTER IN ROLL KERB & GUTTER IN ACCORDANCE WITH PRINTERVANCE OF THE SECRED AND TORFED MEETS STALL BE OVER A 5 HOUTH PERIOD. FOR THE FOLL WIDTH OF ALL EARTH STANDING MAINS. AGO ON THE FOLL WIDTH OF ALL EARTH STANDING MAINS AT THE TOP OF CUT BATTERS. MULCH (IF AVAILABLE FROM SITE CLEARING) AND SEED ALL OTHER DISTURBED AREAS, INCLUDING TRENCHES. WHERE ADJOINING WALLARAH NATIONAL PARK, VEGETATION TO BE IN ACCORDANCE WITH THE VEGETATION MANAGEMENT PLAN. LMCC EGSD-602 STD DWG EGSD -101 STD DWG EGSD -101 SITE REGRADE 17. ALL PERAMBULATOR RAMPS TO BE CONSTRUCTED AS SHOWN ON PLANS AND IN ACCORDANCE WITH LMCC STANDARD DRAWINGS EGSD-101 & EGSD-102. PROVIDE 1.2m WIDE CONCRETE -(MAX 1.5m HIGH) FOOTPATH, IN ACCORDANCE WITH 18. TRAFFIC CONTROL MEASURES TO BE IN ACCORDANCE WITH AS 1742.3-1996 PAVEMENT DESIGN TO BE IN-LMCC STD DWG EGSD-301 GEOTECHNICAL REPORT 19. ALL LEVELS MUST BE OBTAINED FROM ESTABLISHED BENCH MARKS AS DIRECTED BY THE SUPERVISOR PROVIDE SUBSOIL DRAINAGE TO BOTH PROVIDE SUBSOIL DRAINAGE TO BOTH SIDES OF ROAD TO COUNCIL SIDES OF ROAD TO COUNCIL STANDARD DETAILS. REFER TO GEOTECHNICAL REPORT TYPICAL SECTION - ROAD 1 CH 180.00 - 315.239 20. THE CONTRACTOR IS TO ENSURE THAT ALL THE NECESSARY SERVICE PIPE CONDUITS AND FITTINGS ARE IN PLACE PRIOR TO THE FINAL WEARING COURSE BEING LAID. 22. PROVIDE STREET NAME SIGNS AT ALL INTERSECTIONS, DOUBLE BLADED WHERE NECESSARY ON BLACK POWDER COATED STANDARD DETAILS, REFER TO SCALE 1:50 POLES. 21. ALL SITE FILLING TO BE CONTROLLED FILL TO AS3798 WITH TESTING TO BE CARRIED OUT BY A NATA REGISTERED LABORATORY 22. PROVIDE ANCHOR BLOCKS AT EACH JOINT ON DRAINAGE LINES WHERE PIPE GRADE EXCEEDS 12%. - ROLL KERB & GUTTER IN ROLL KERB & GUTTER IN CCORDANCE WITH LMCC STD DWG EGSD -101 ACCORDANCE WITH LMCC STD DWG EGSD -101 ____SITE REGRADE PROVIDE 1.2m WIDE CONCRETE EDDTPATH IN ACCORDANCE WITH LMCC STD DWG EGSD-301 ACCORDANCE WITH THE GEOTECHNICAL REPORT PROVIDE SUBSOIL DRAINAGE TO BOTH PROVIDE SUBSOIL DRAINAGE TO BOTH SIDES OF ROAD TO COUNCIL STANDARD DETAILS. REFER TO GEOTECHNICAL REPORT SIDES OF ROAD TO COUNCIL STANDARD DETAILS. REFER TO GEOTECHNICAL REPORT TYPICAL SECTION - ROAD 1 CH 0.00 - 180.00 1.00m (MIN) 3.00m (MIN TOP OF WALL 600 WIDE 10.00m COUNCIL RESERVE MAGNUMSTONE WALL TYPICAL SECTION 6.00m PUBLIC ROAD WIDTH (TYP) **SCALE 1:25** CONCRETE ROLL KERB & GUTTER IN ACCORDANCE 3 00m (MIN UNSEALED UNSEALE 25% 1.00m SHOULDER 4.00m SEALED ROAD SHOULDE (WHERE REQUIRED, SUBJECT SIDE OF WALL (TYP) TO FINAL DESIGN AT SWC) FOR PAVEMENT DETAILS REFER TO GEOTECHNICAL REPORT BATTER / LOT REGRADE (OR LOW SIDE FILL) PROVIDE SUBSOIL DRAINAGE TO COUNCIL STANDARD DETAILS. RETAINING WALL (MAX 1.5m HIGH) (OR BATTER WHERE SHOWN ON PLAN AND TYPICAL RETAINING WALL SECTION SECTION SUBJECT TO DETAIL DESIGN AT SWC) TYPICAL SECTION - ROAD 5 PRELIMINARY ISSUE SCALE 1:25 **SCALE 1:50** Designed Cad Reference Project No PROPOSED SUBDIVISION COPYRIGHT A.M 19259C dC404 r4 Copyright in the drawings, information and data recorded hereon is the property of Geoff Craig & Associates Pty Ltd and may not be used, copied or reproduced in whole or part for any purpose other than that for which it 19259C 1A FLOWERS DRIVE A1 SHEET MAGNUMSTONE TYPICAL SECTION ADDED AS 27.07.22 1:50 CATHERINE HILL BAY CLIENT AMENDMENTS DB AS 11.01.22 Drawing No Revisio

Project Approval

Consulting Civil Enginee

IAN HILL (B.E)

supplied without the prior consent

of Geoff Craig & Associates Pty Ltd.

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PHONE: (02) 4964 1811

(HAMLET A)

TYPICAL SECTIONS AND NOTES

(404)

DB

D.B

AS


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LIENT AMENDMENTS

ORIGINAL ISSUE





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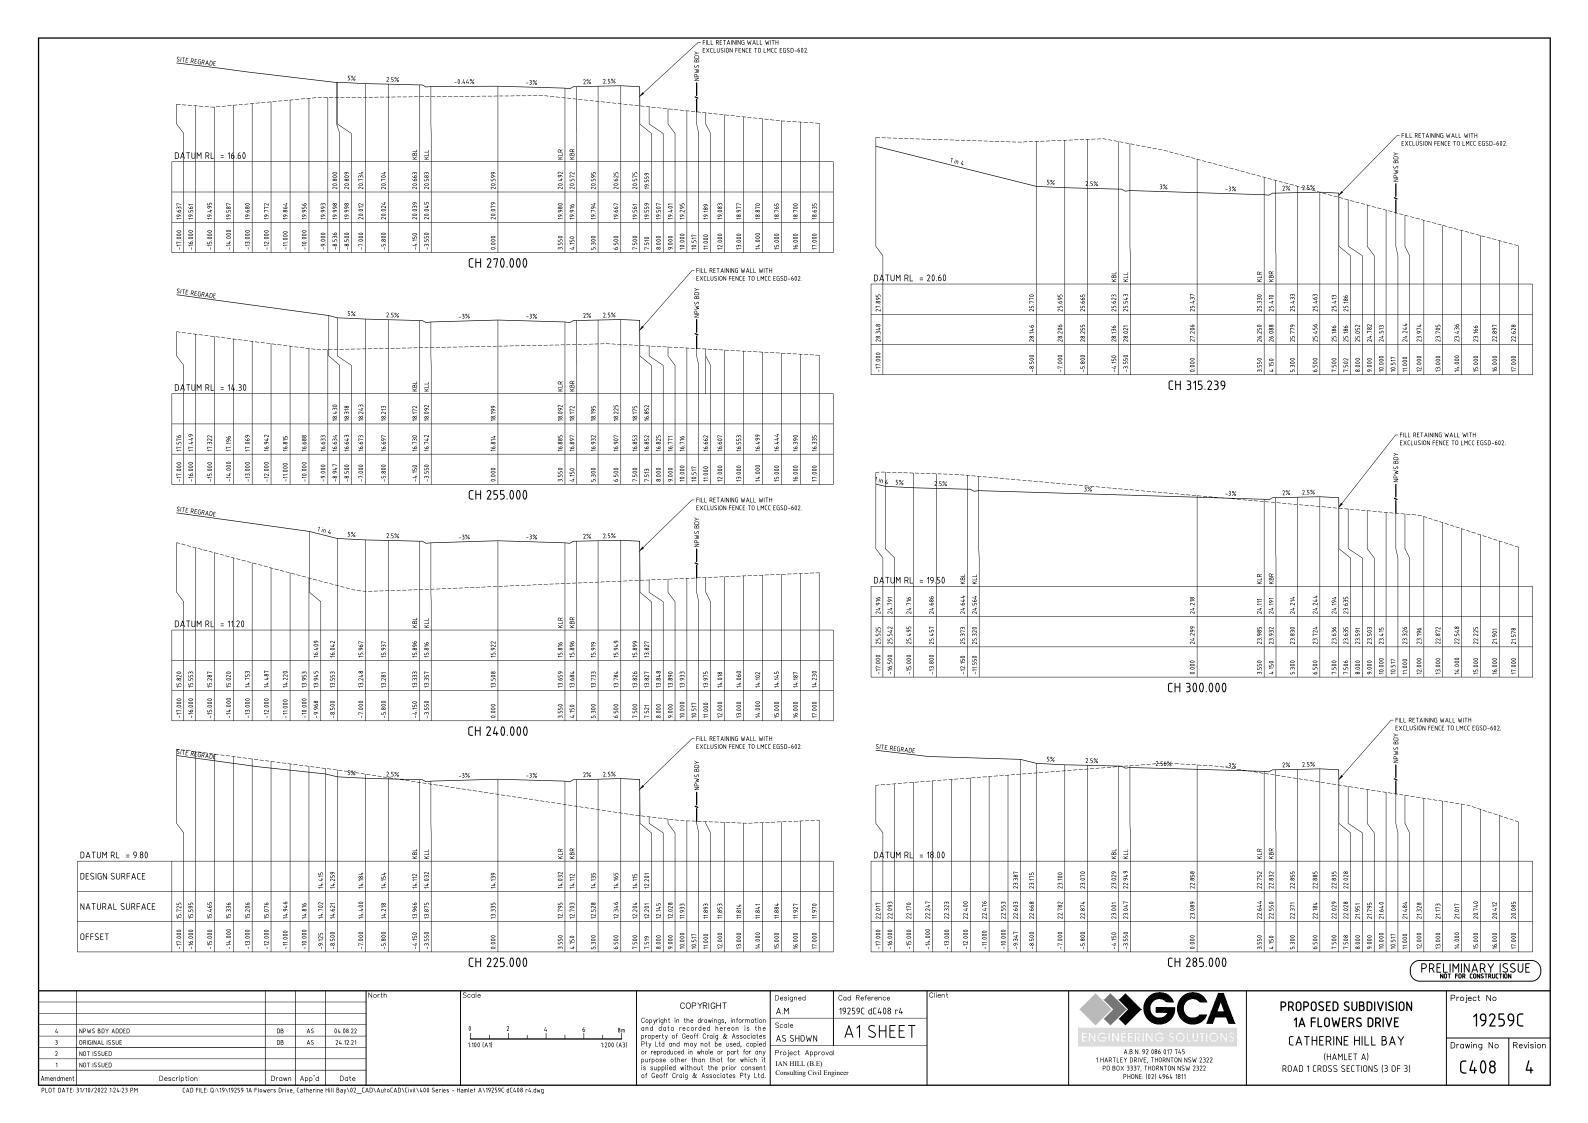
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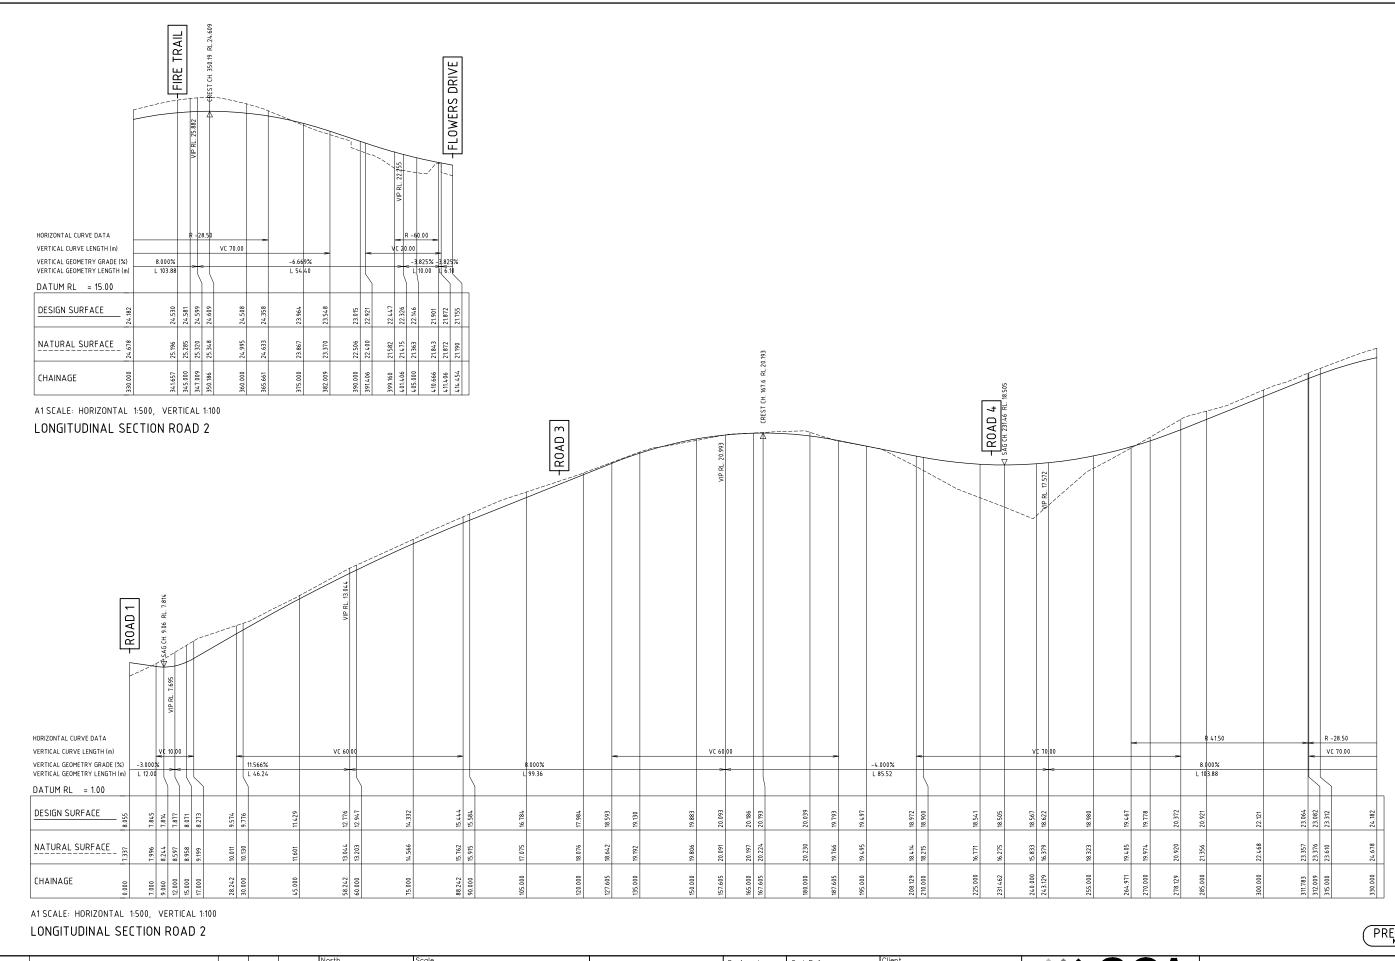
PROPOSED SUBDIVISION 1A FLOWERS DRIVE CATHERINE HILL BAY (HAMLET A) ROAD 1 LONGITUDINAL SECTION


Project No 19259C

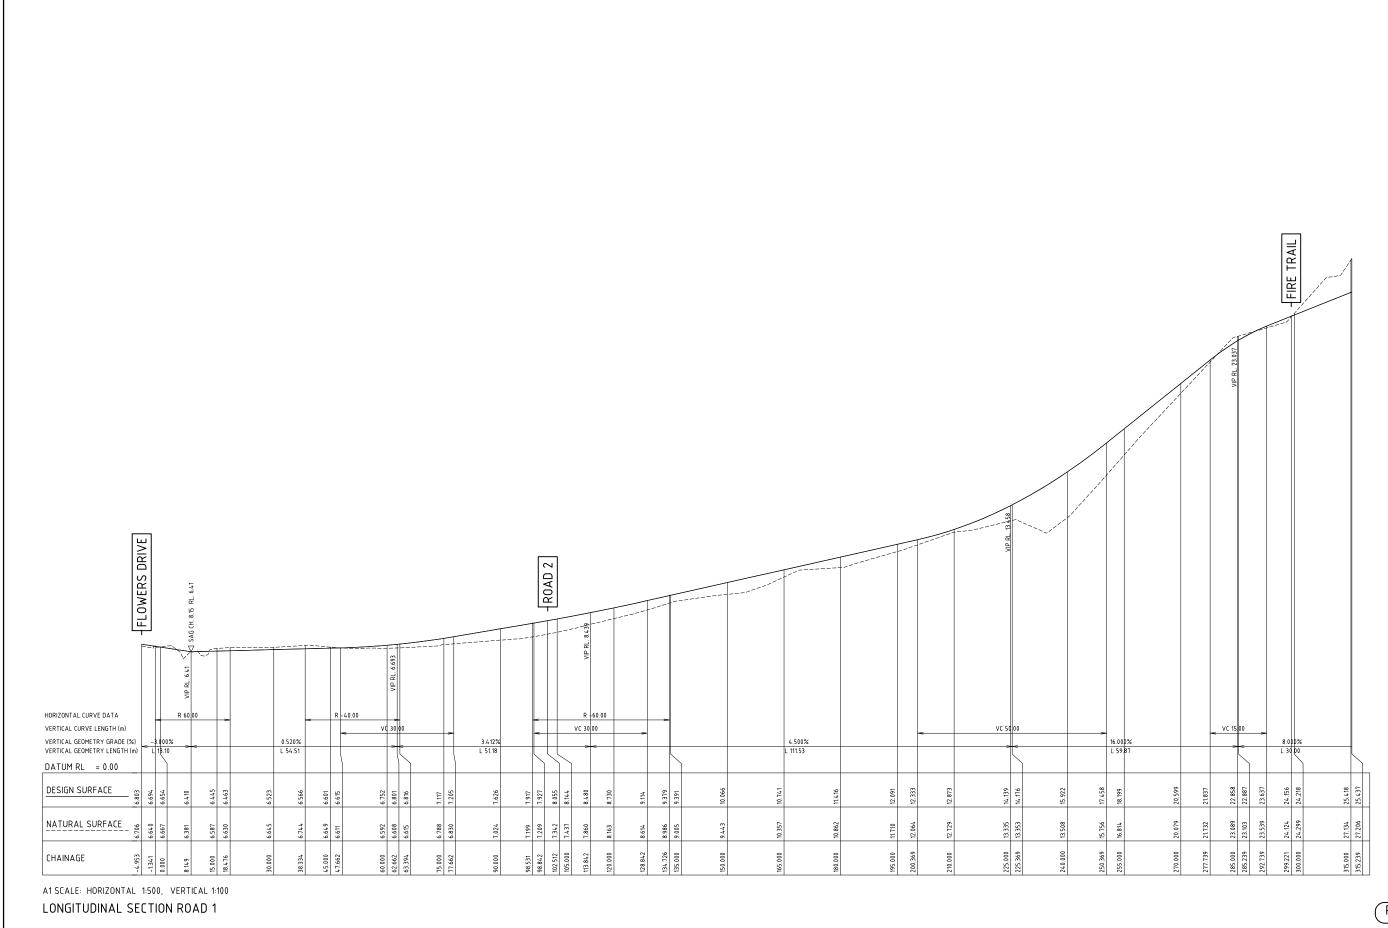



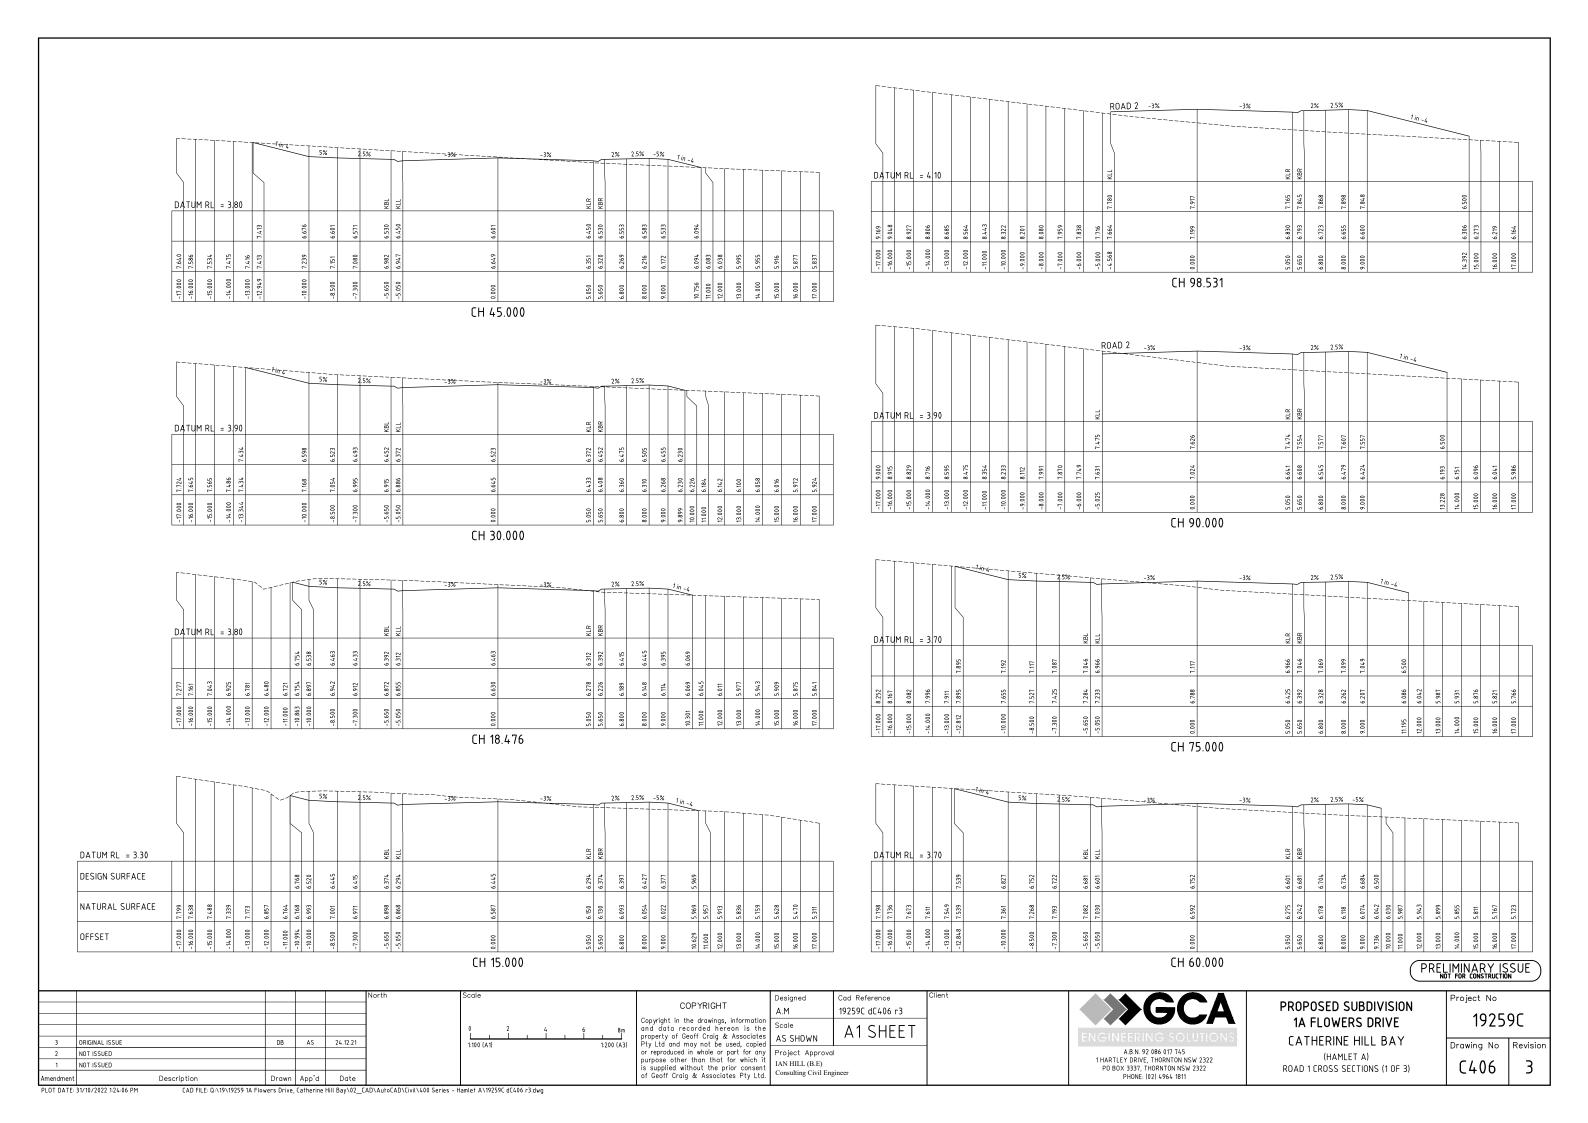

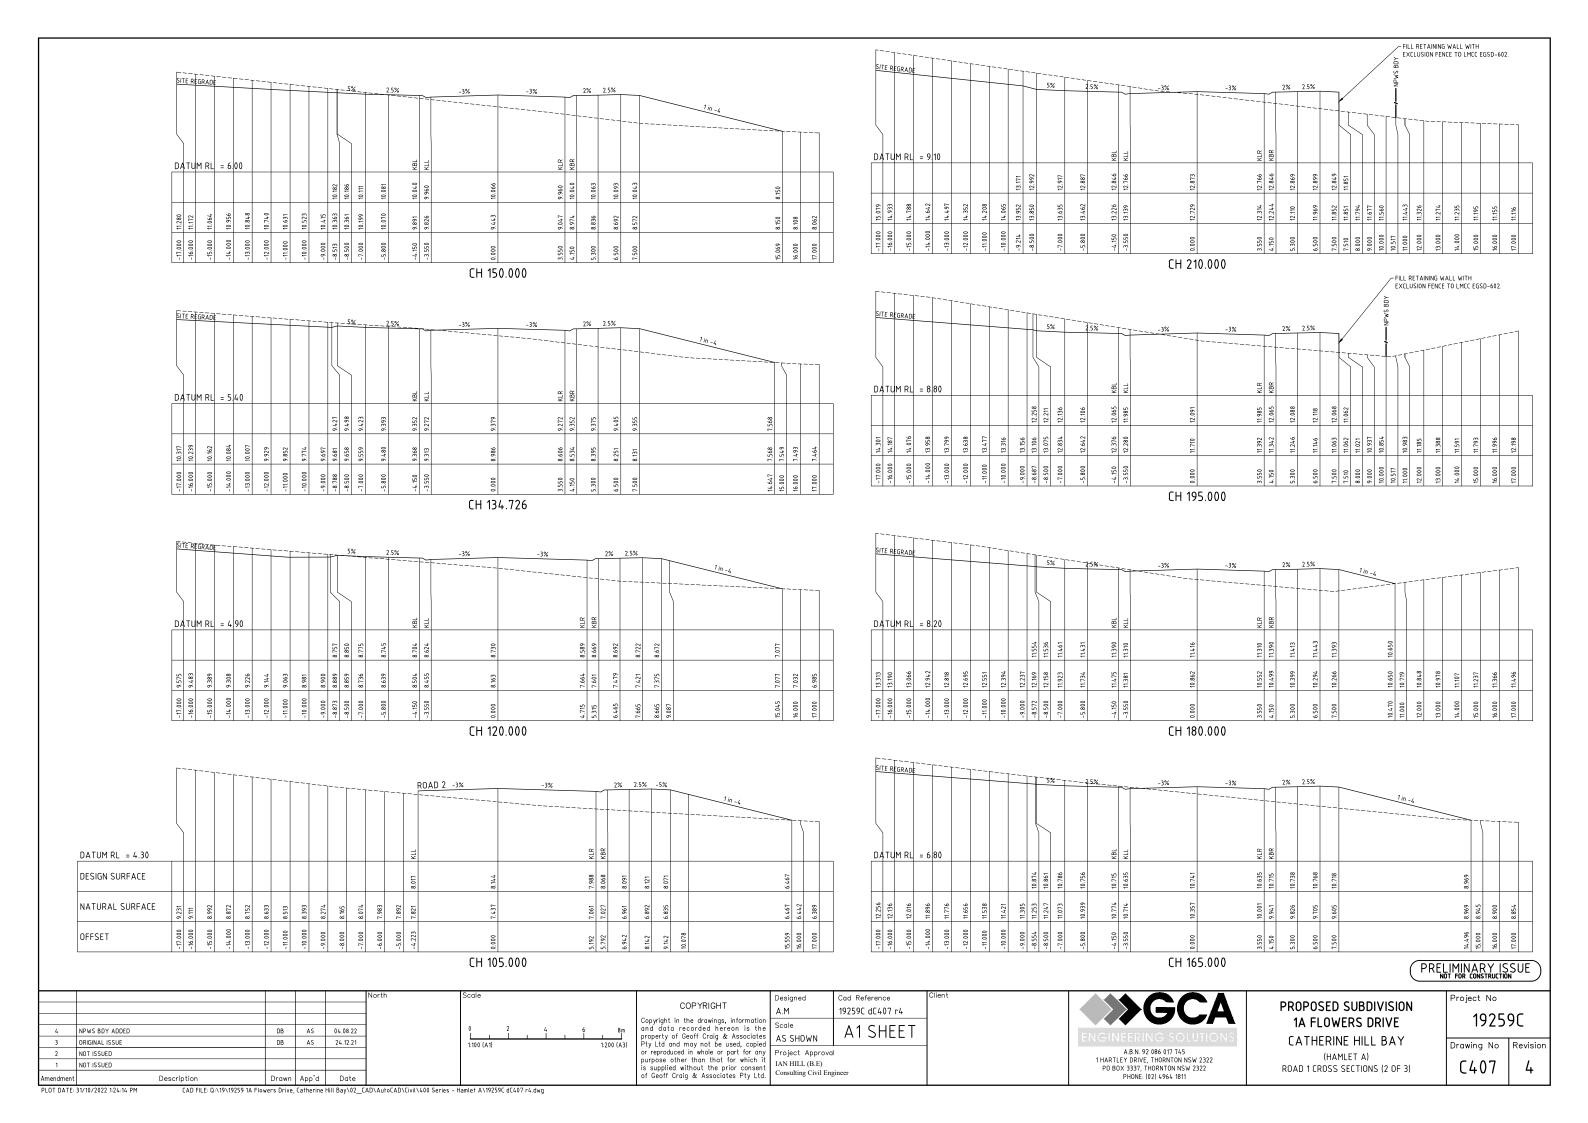

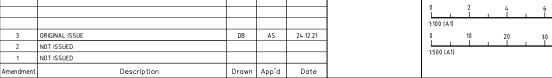

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Consulting Civil Engineer



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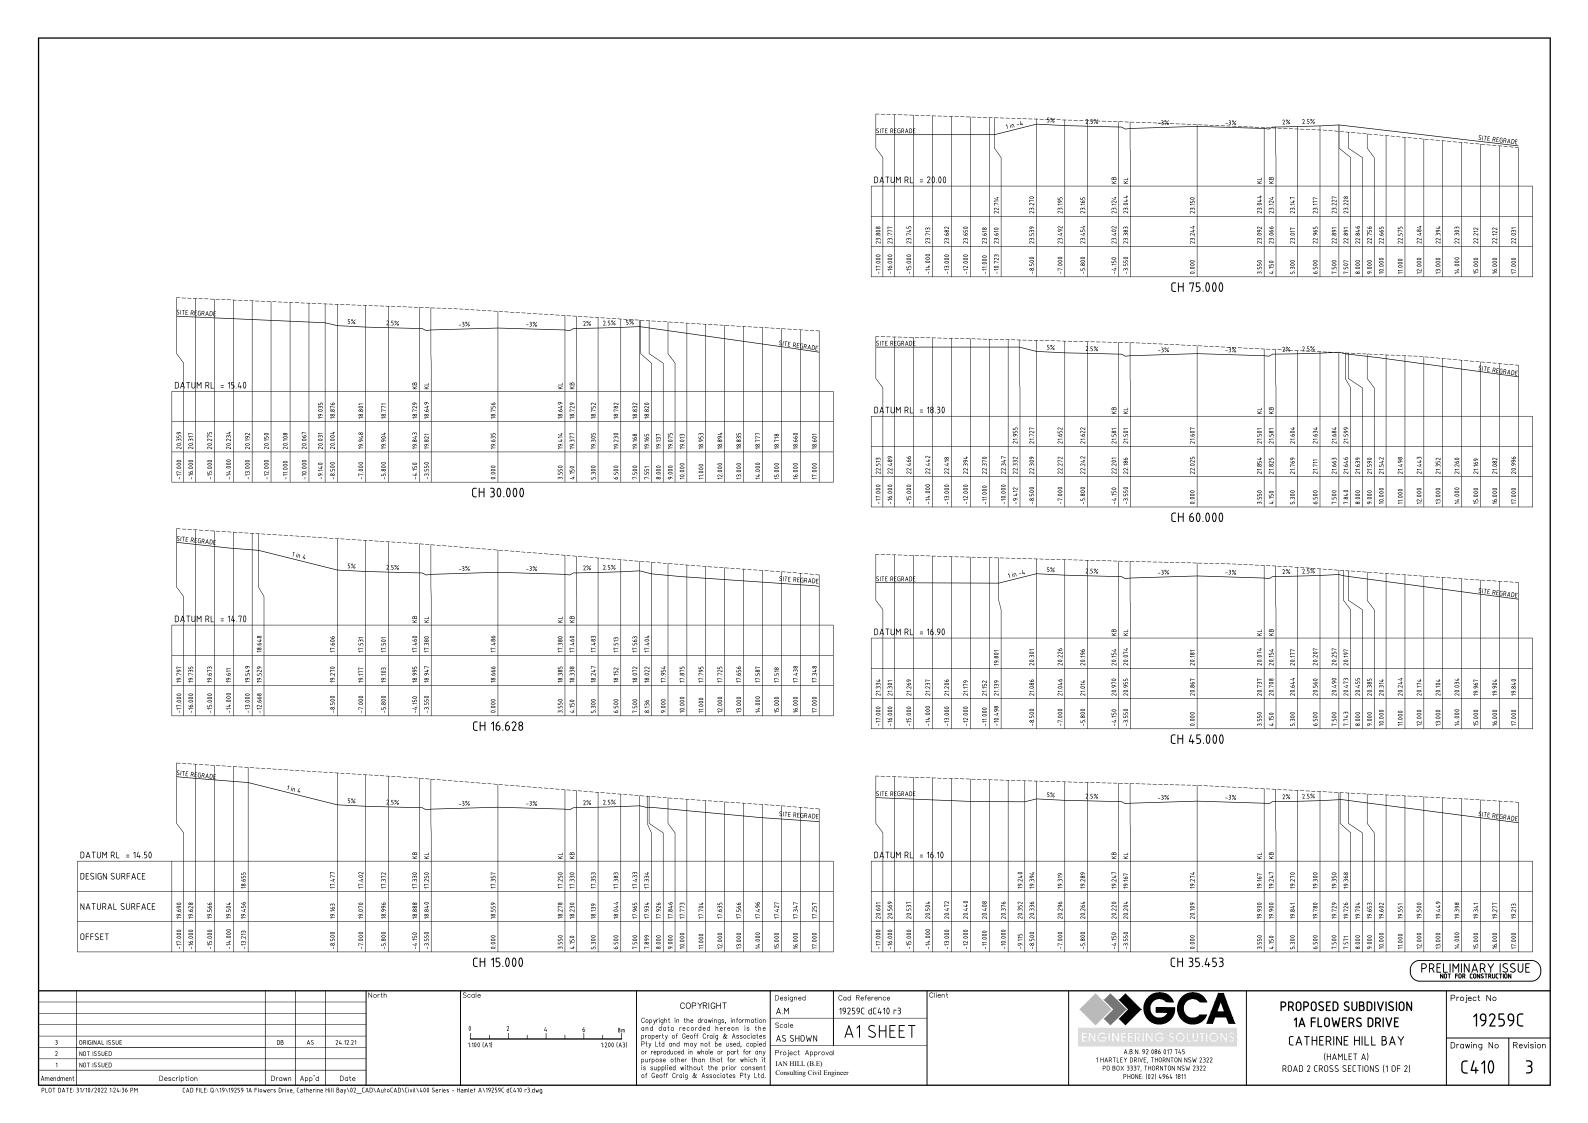
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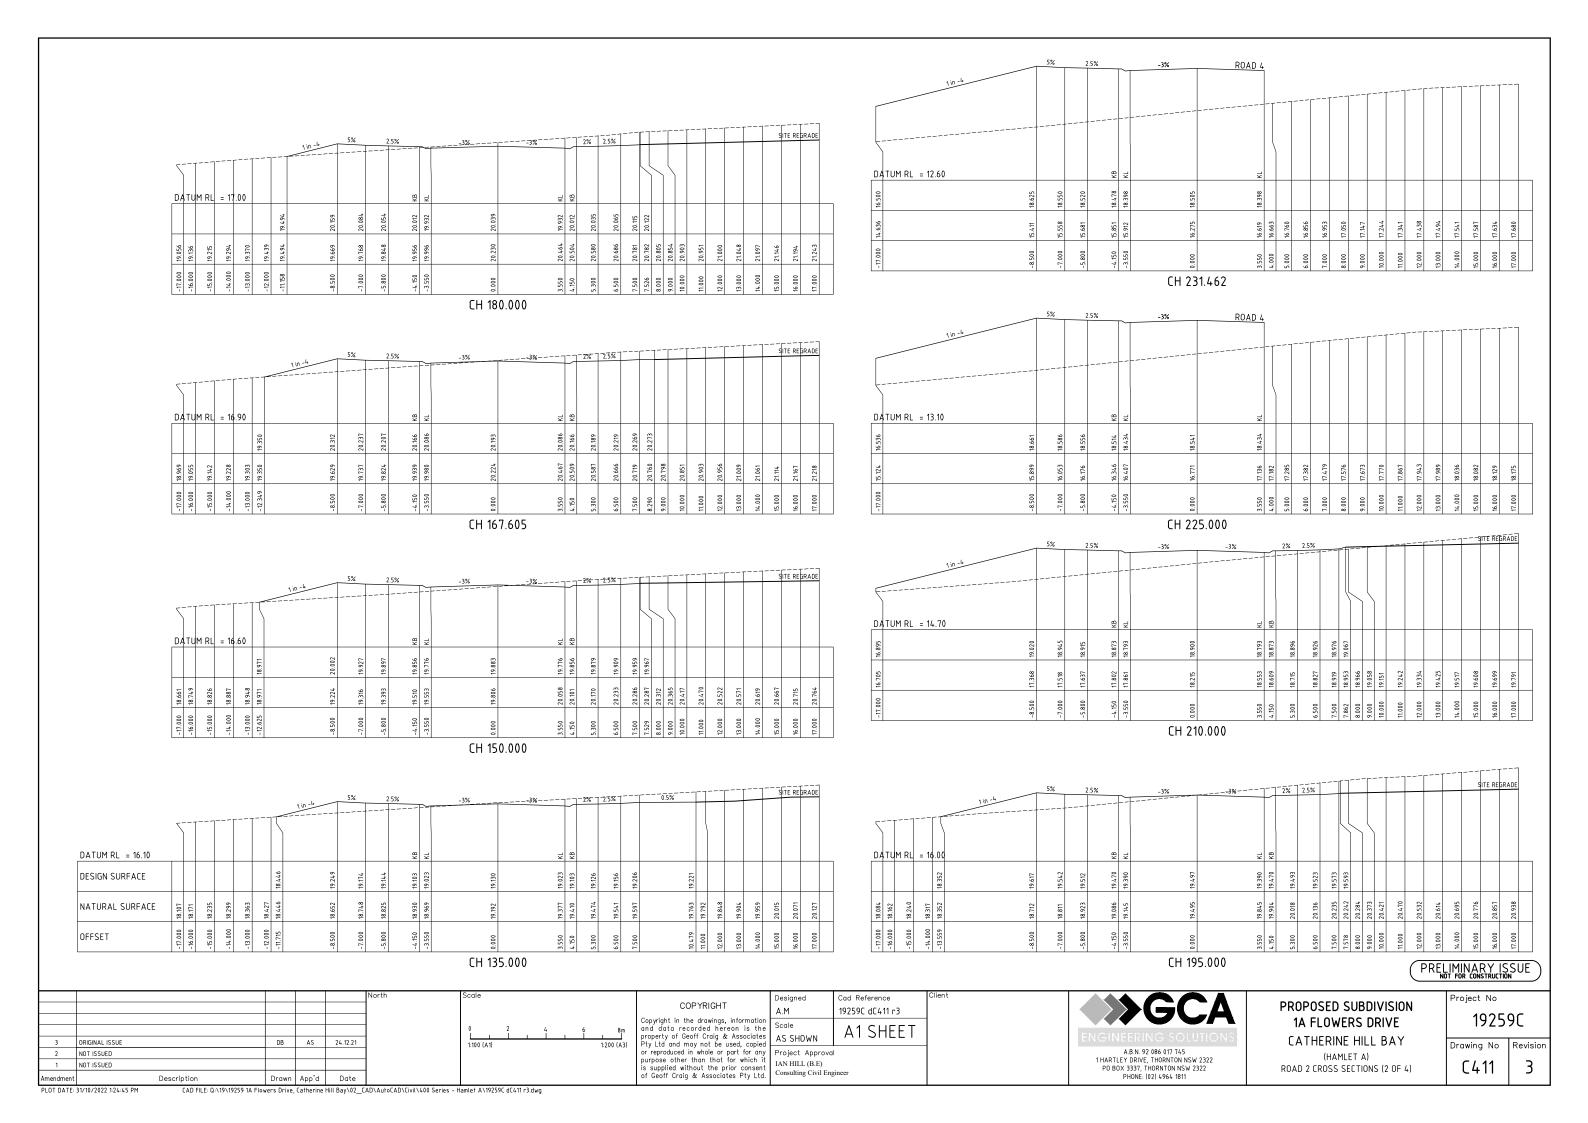
ROAD 2 LONGITUDINAL SECTION


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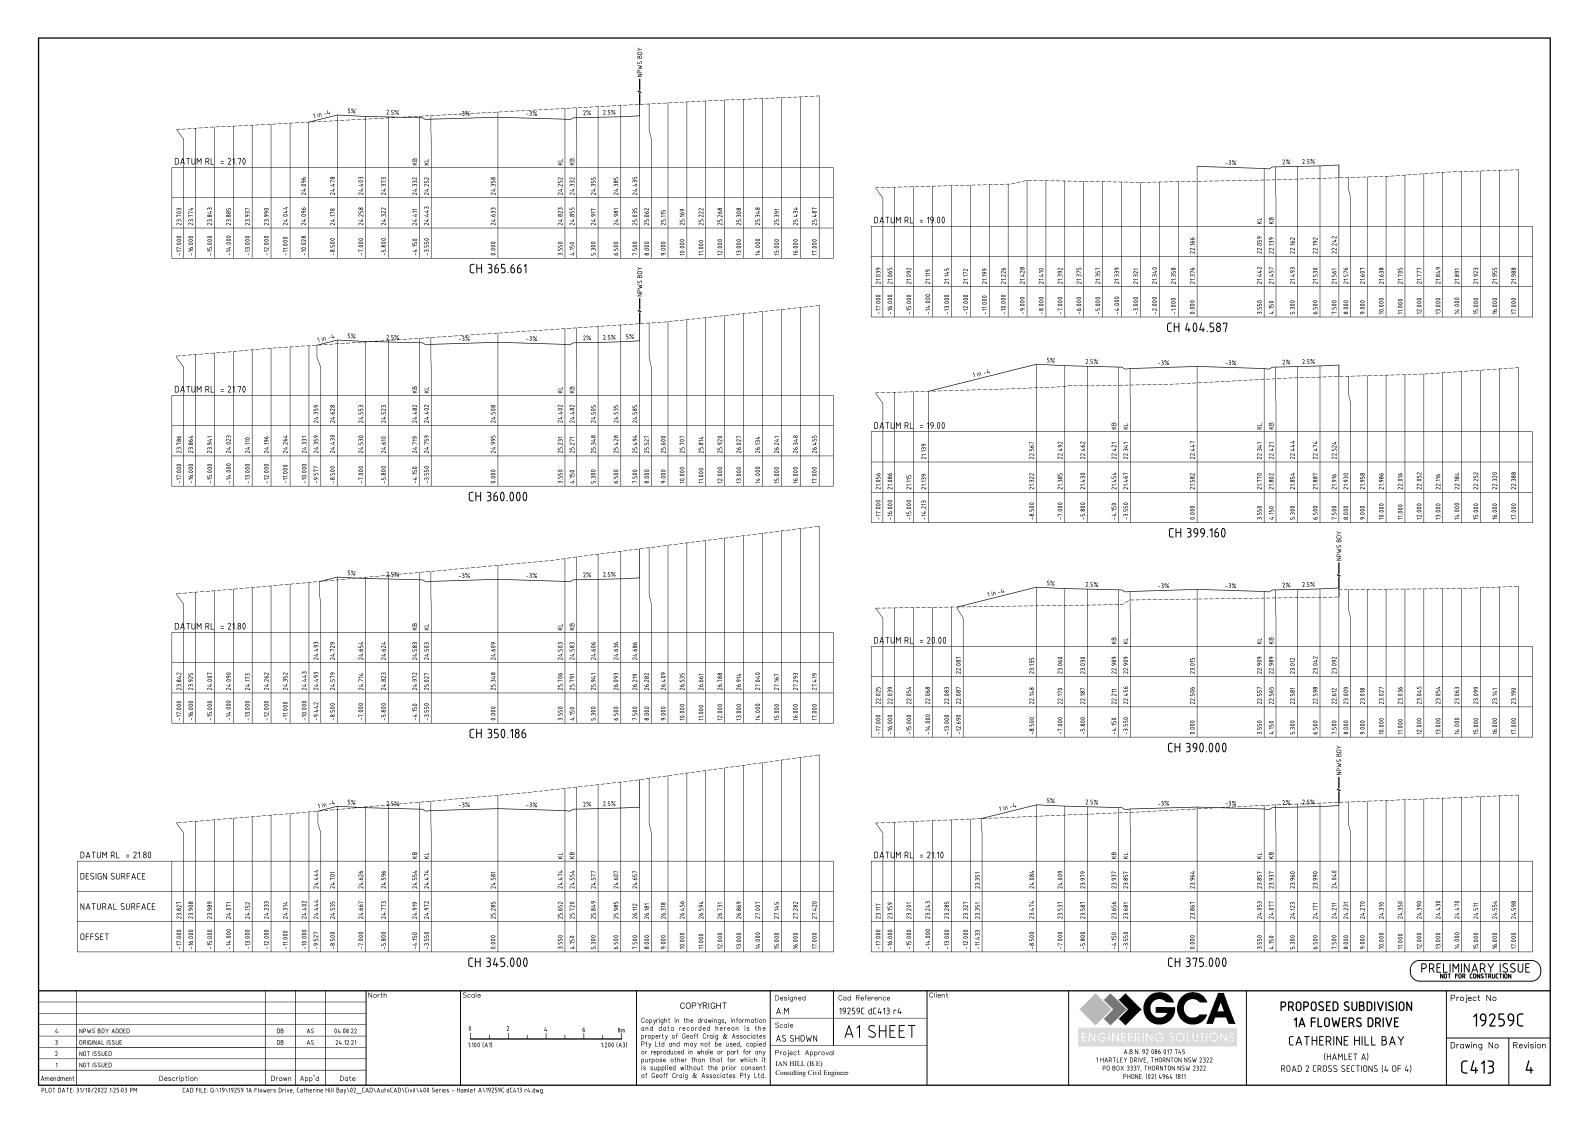
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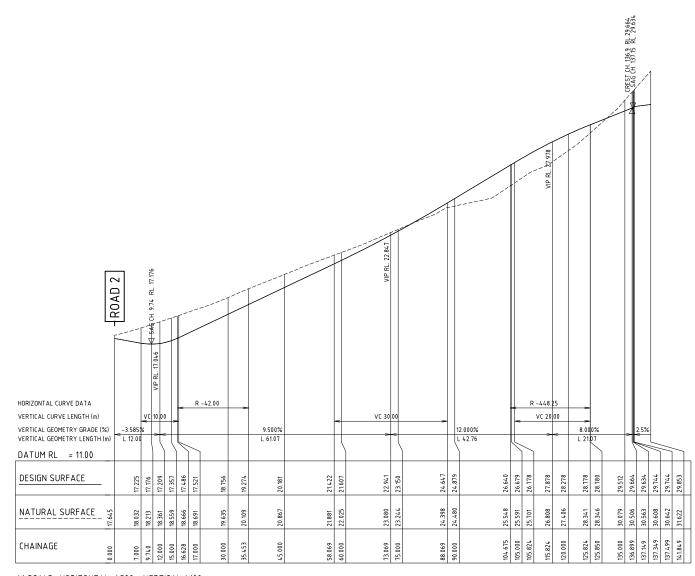
Revision C409 3









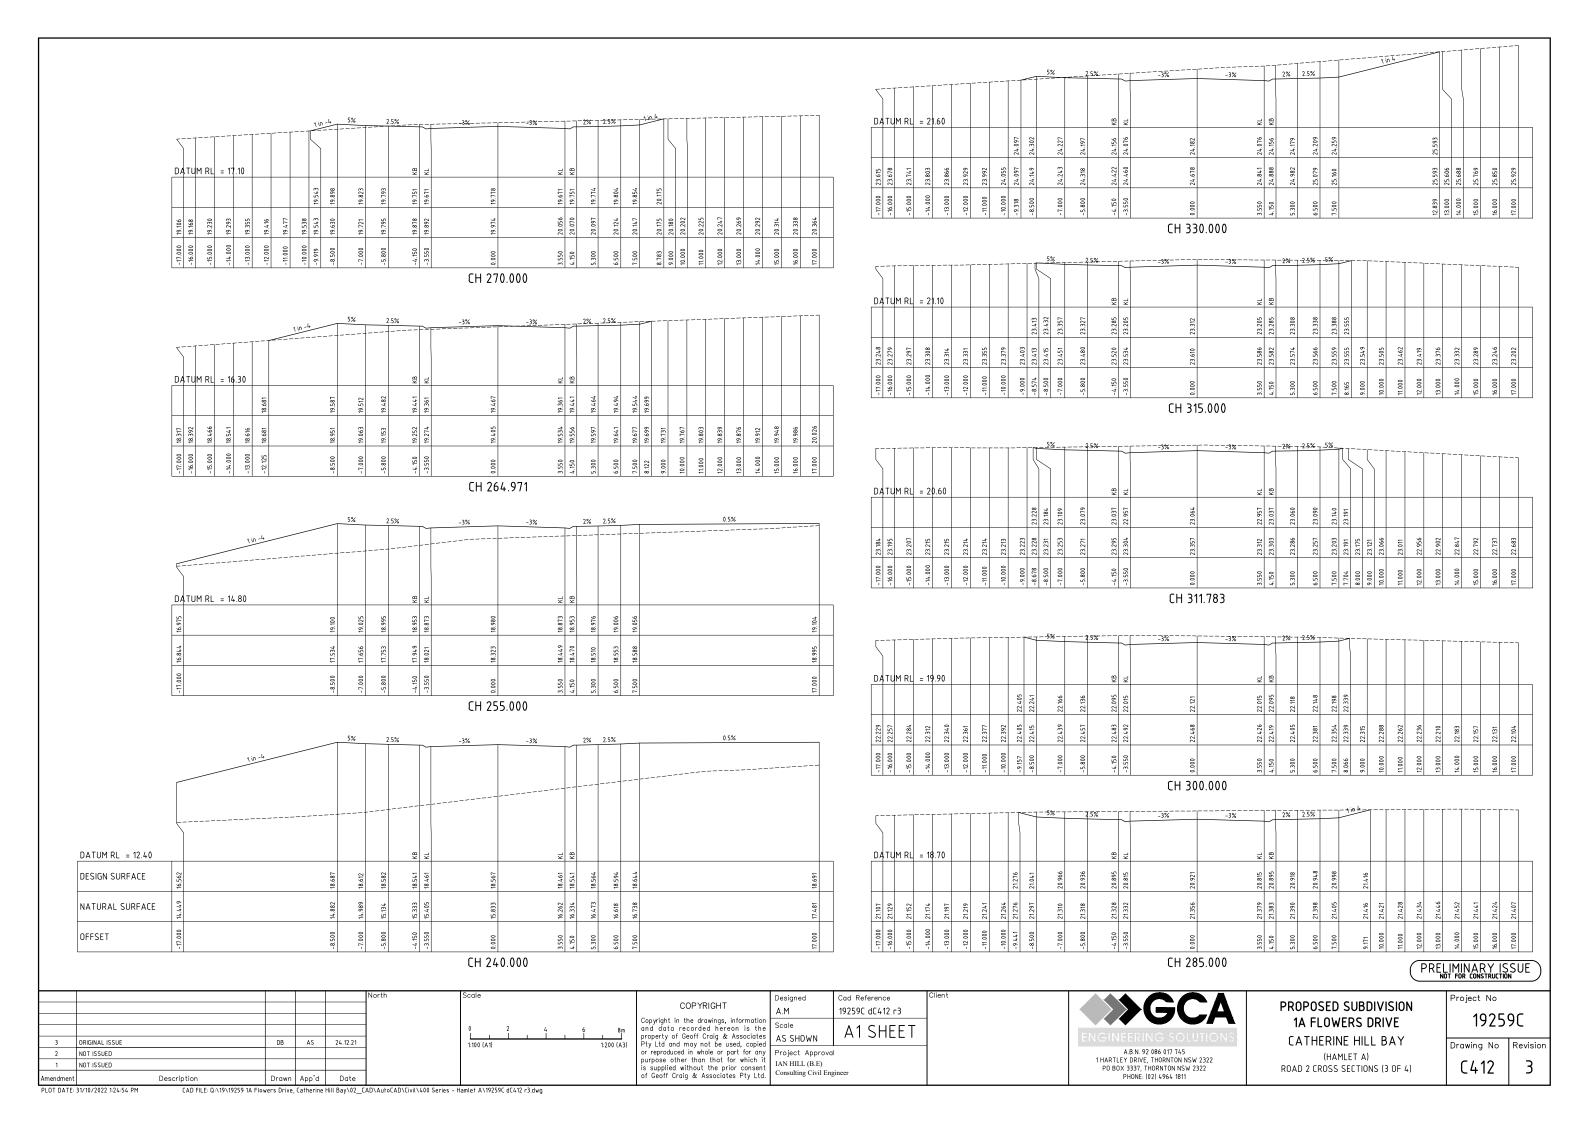

A1 SCALE: HORIZONTAL 1:500, VERTICAL 1:100 LONGITUDINAL SECTION ROAD 3

PRELIMINARY ISSUE

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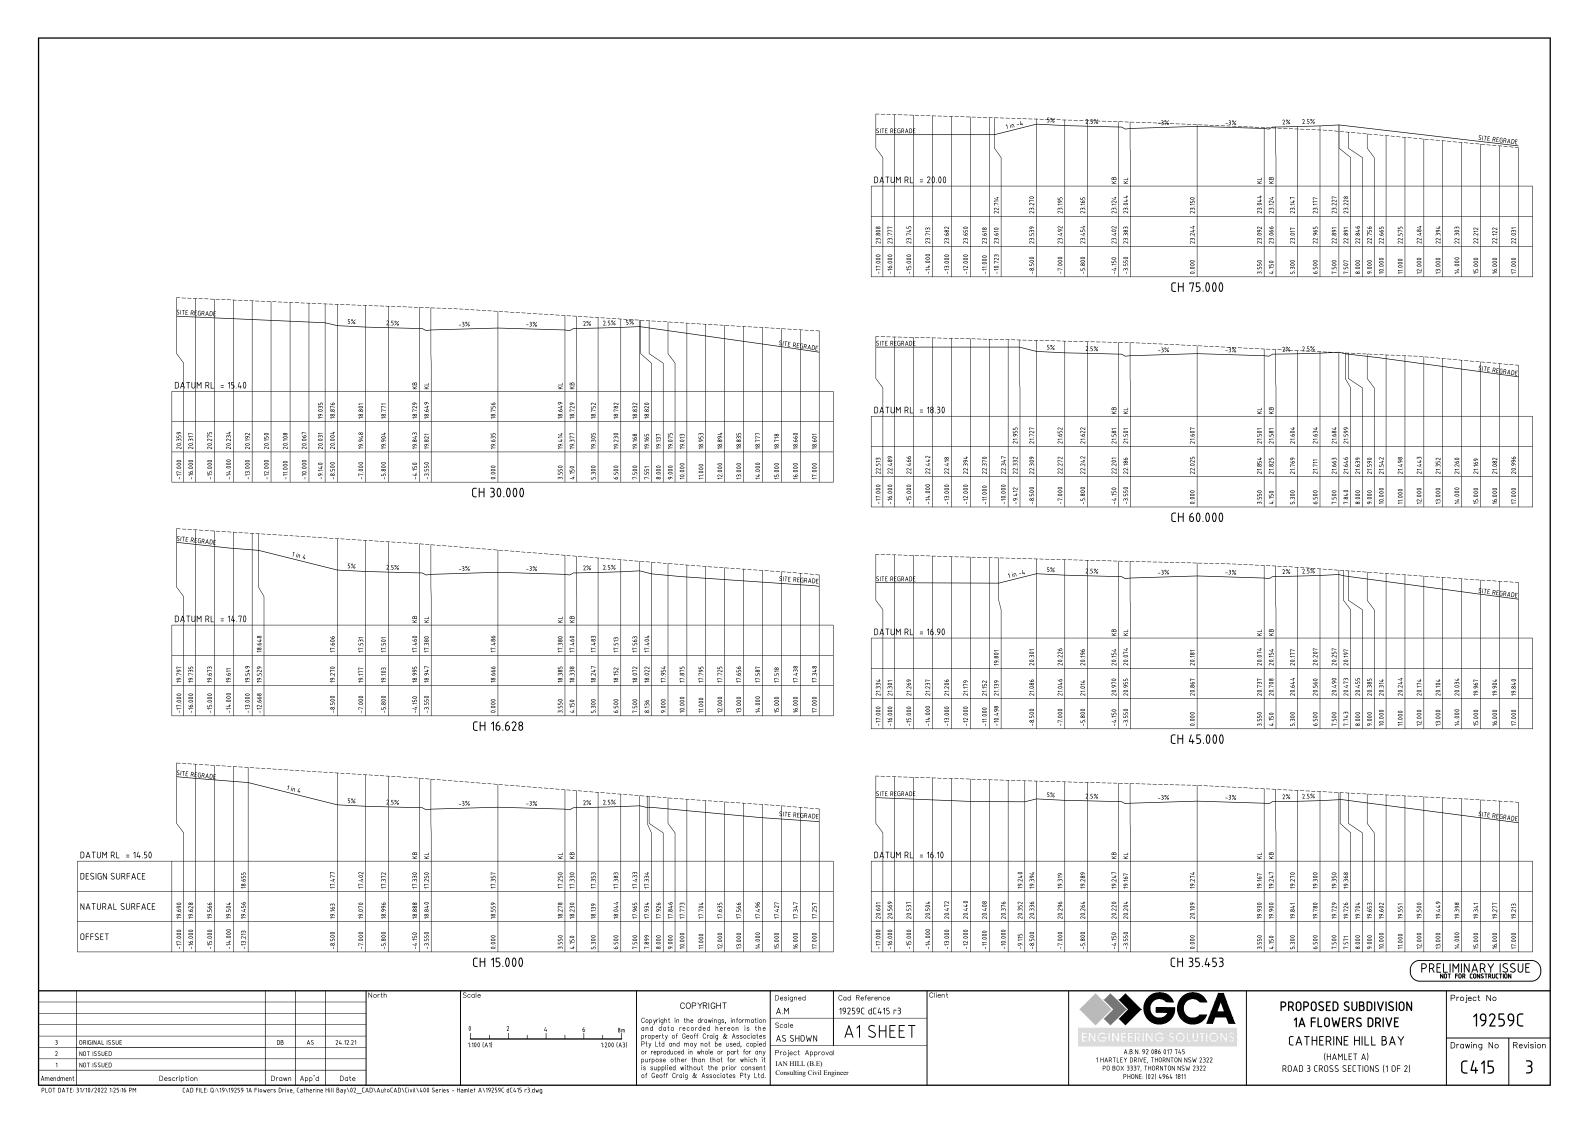
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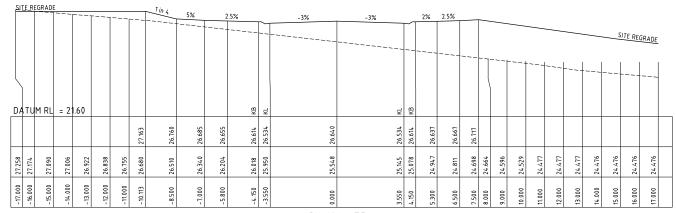


1A FLOWERS DRIVE CATHERINE HILL BAY (HAMLET A) ROAD 3 LONGITUDINAL SECTION


PROPOSED SUBDIVISION

Project No 19259C





CH 104.675

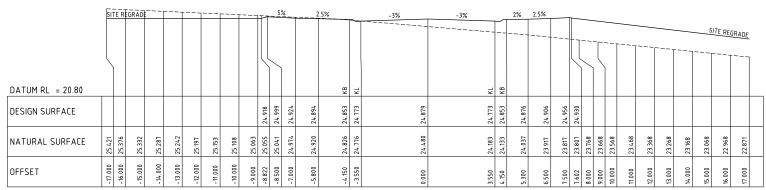

CH 90.000


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PROPOSED SUBDIVISION 1A FLOWERS DRIVE CATHERINE HILL BAY (HAMLET A) ROAD 3 CROSS SECTIONS (2 OF 2) Project No 19259C



A1 SCALE: HORIZONTAL 1:500, VERTICAL 1:100 LONGITUDINAL SECTION ROAD 4

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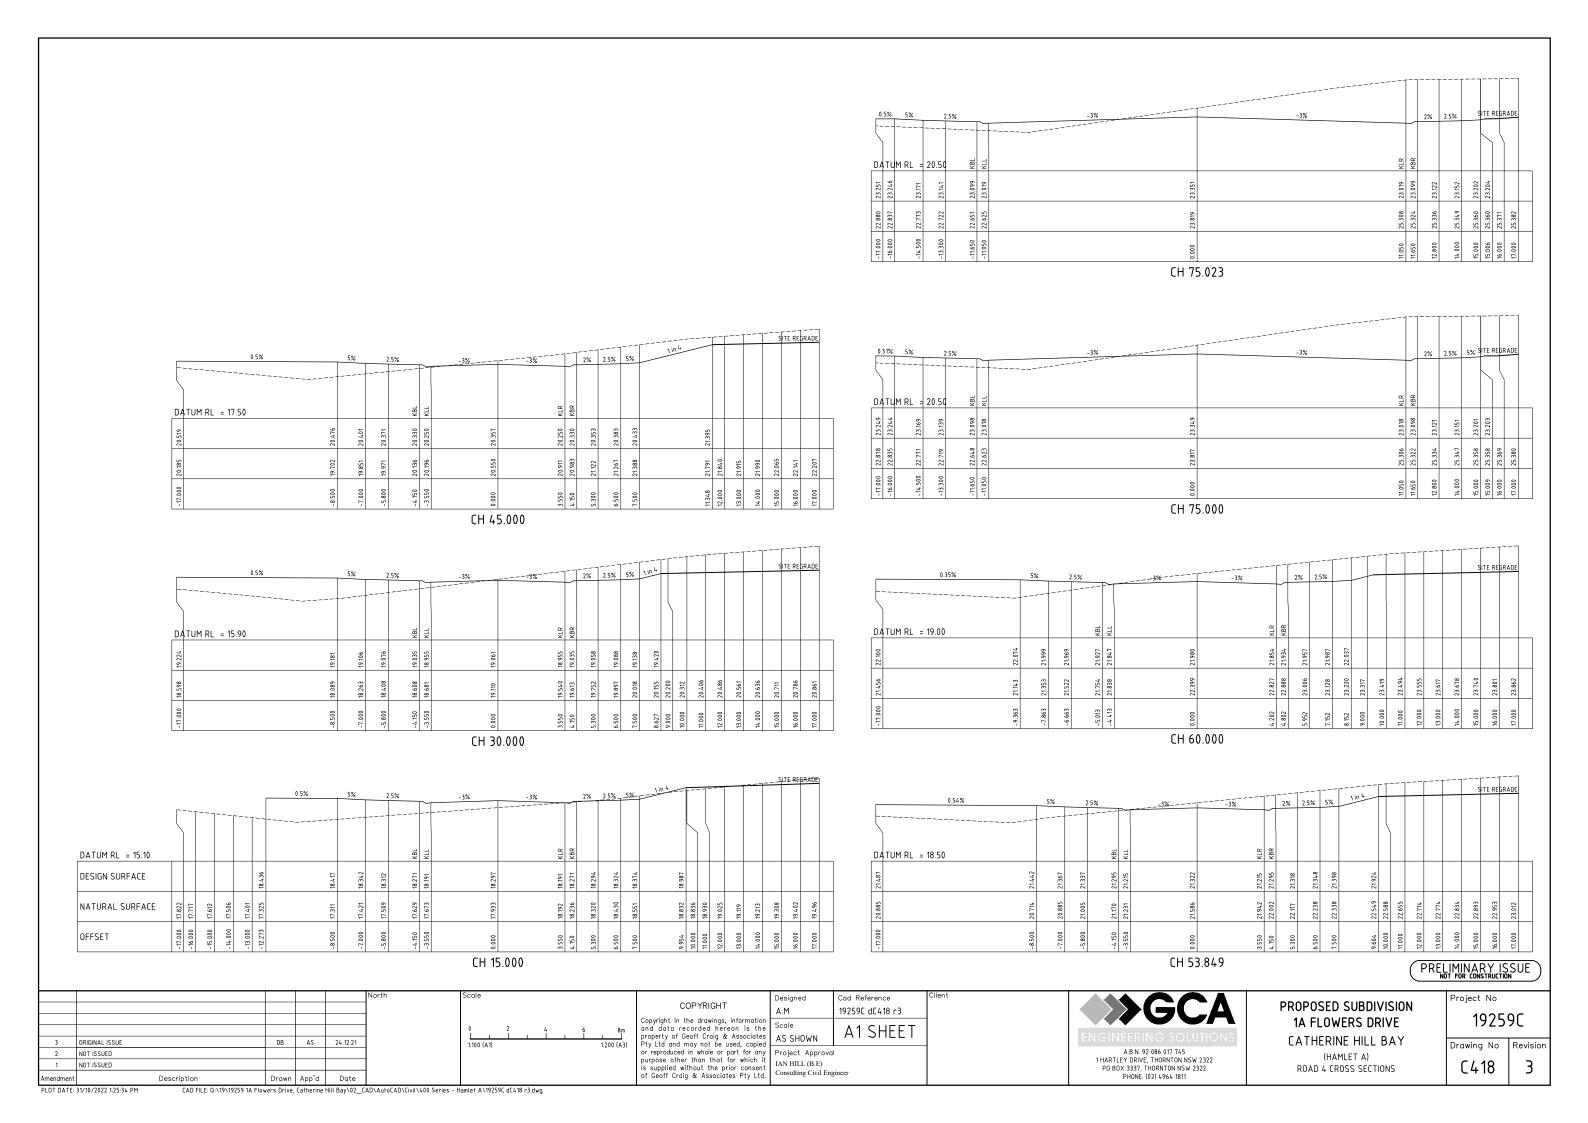
Cad Reference A.M 19259C dC417 r3 A1 SHEET AS SHOWN Project Approval IAN HILL (B.E) Consulting Civil Engineer

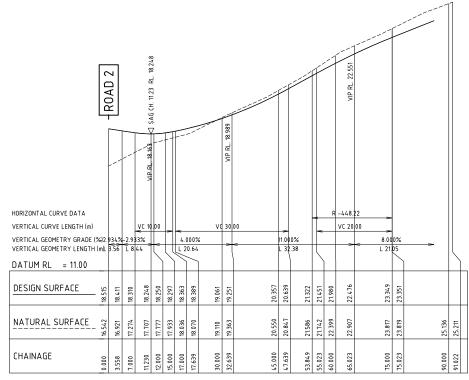


CATHERINE HILL BAY A.B.N. 92 086 017 745 1 HARTLEY DRIVE, THORNTON NSW 2322 PO BOX 3337, THORNTON NSW 2322 PHONE: (02) 4964 1811 (HAMLET A) ROAD 4 LONGITUDINAL SECTION

Project No PROPOSED SUBDIVISION 1A FLOWERS DRIVE

19259C



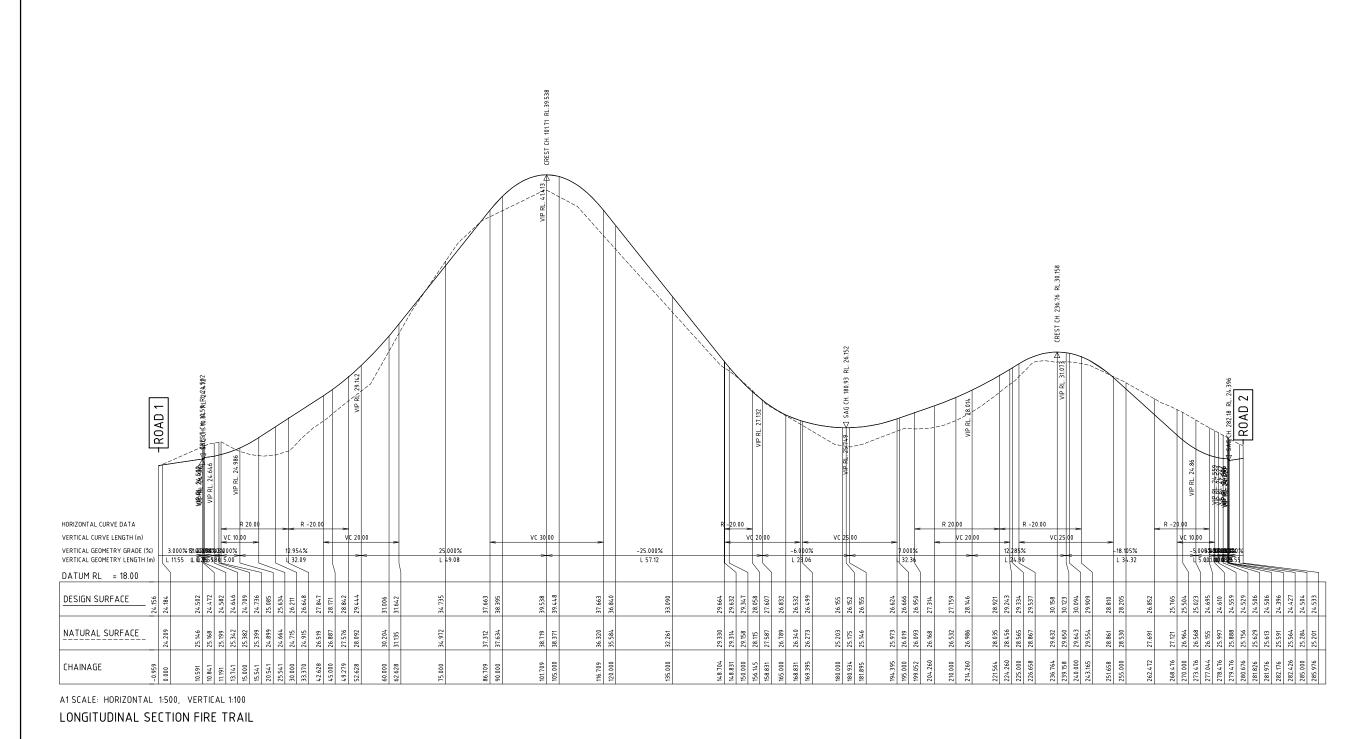

1-10
3 ORIGINAL ISSUE DB AS 24.12.21
2 NOT ISSUED
1 NOT ISSUED
1-50

0 2 4 6 8m 1:100 (A1) 1:200 (A3) 0 10 20 30 40m 1:500 (A1) 1:1000 (A3)

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Designed A.M 19259C dC419 r3
Scale AS SHOWN A1 SHEET
Project Approval IAN HILL (B.E)

Consulting Civil Engineer

SGCA
ENGINEERING SOLUTION
ARN 92 086 017 745

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CATHERINE HILL BAY

(HAMLET A)

ROAD 5 LONGITUDINAL SECTION

PROPOSED SUBDIVISION
1A FLOWERS DRIVE
CATHERINE HILL BAY
(HAMLET A)


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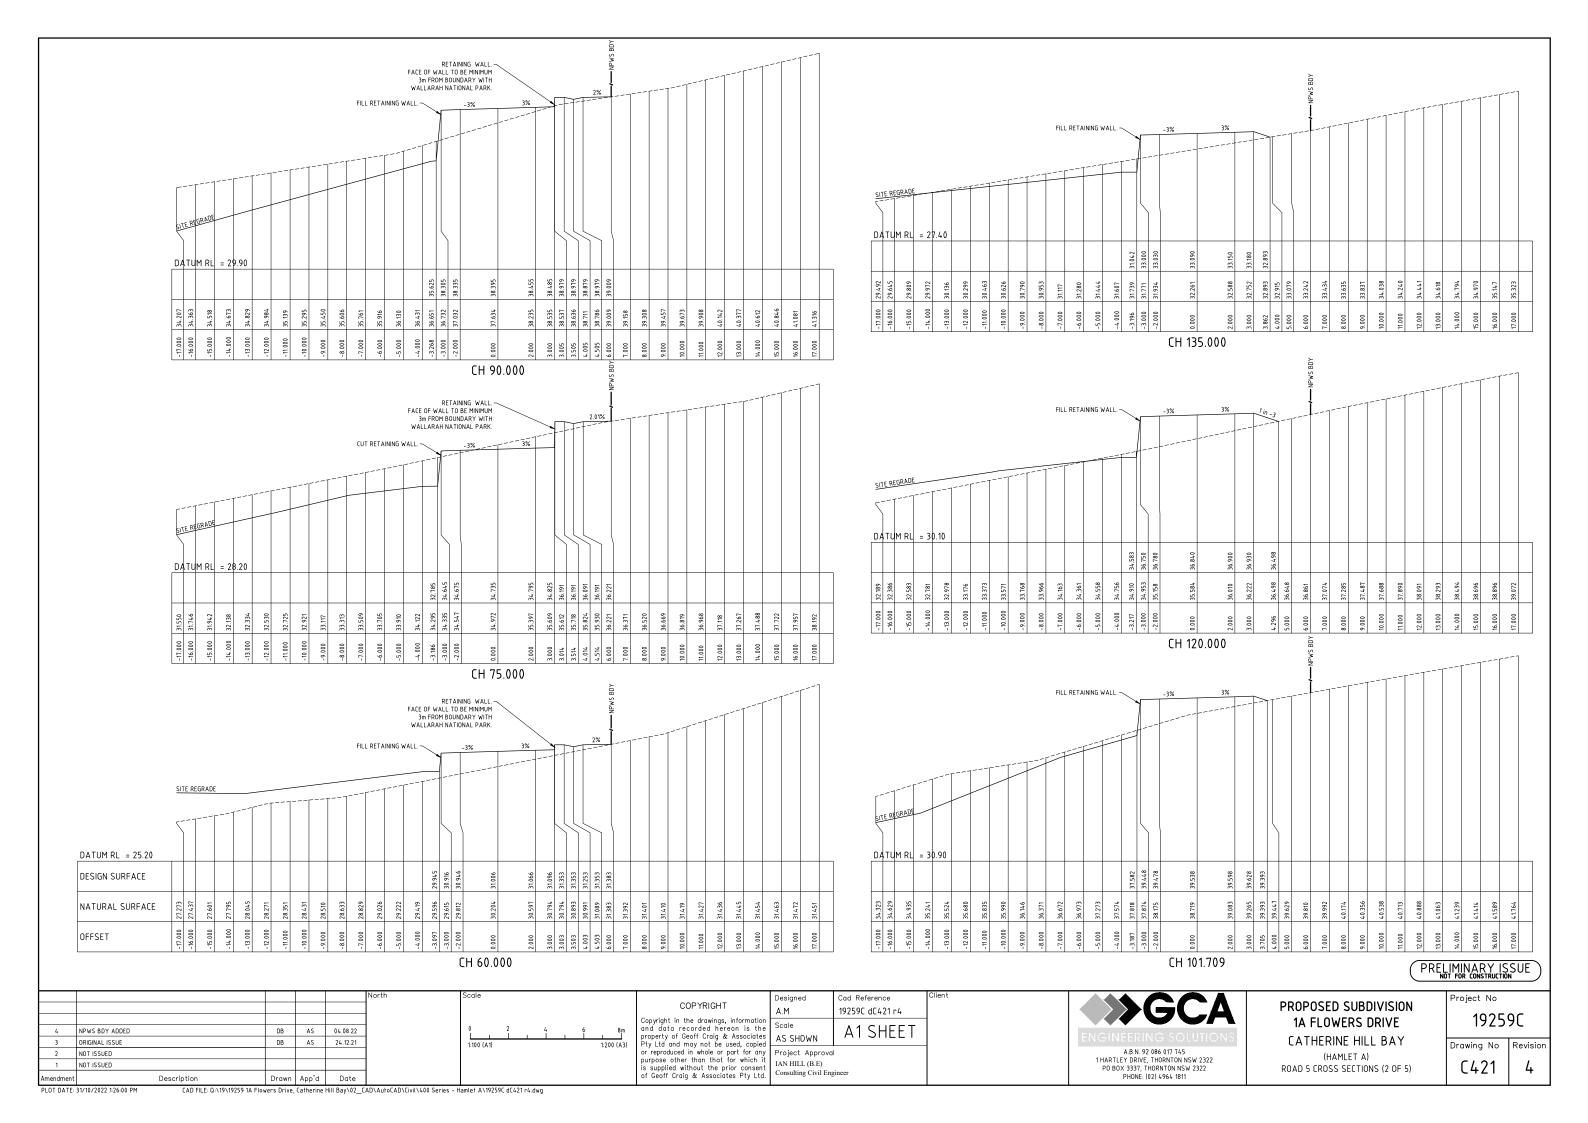
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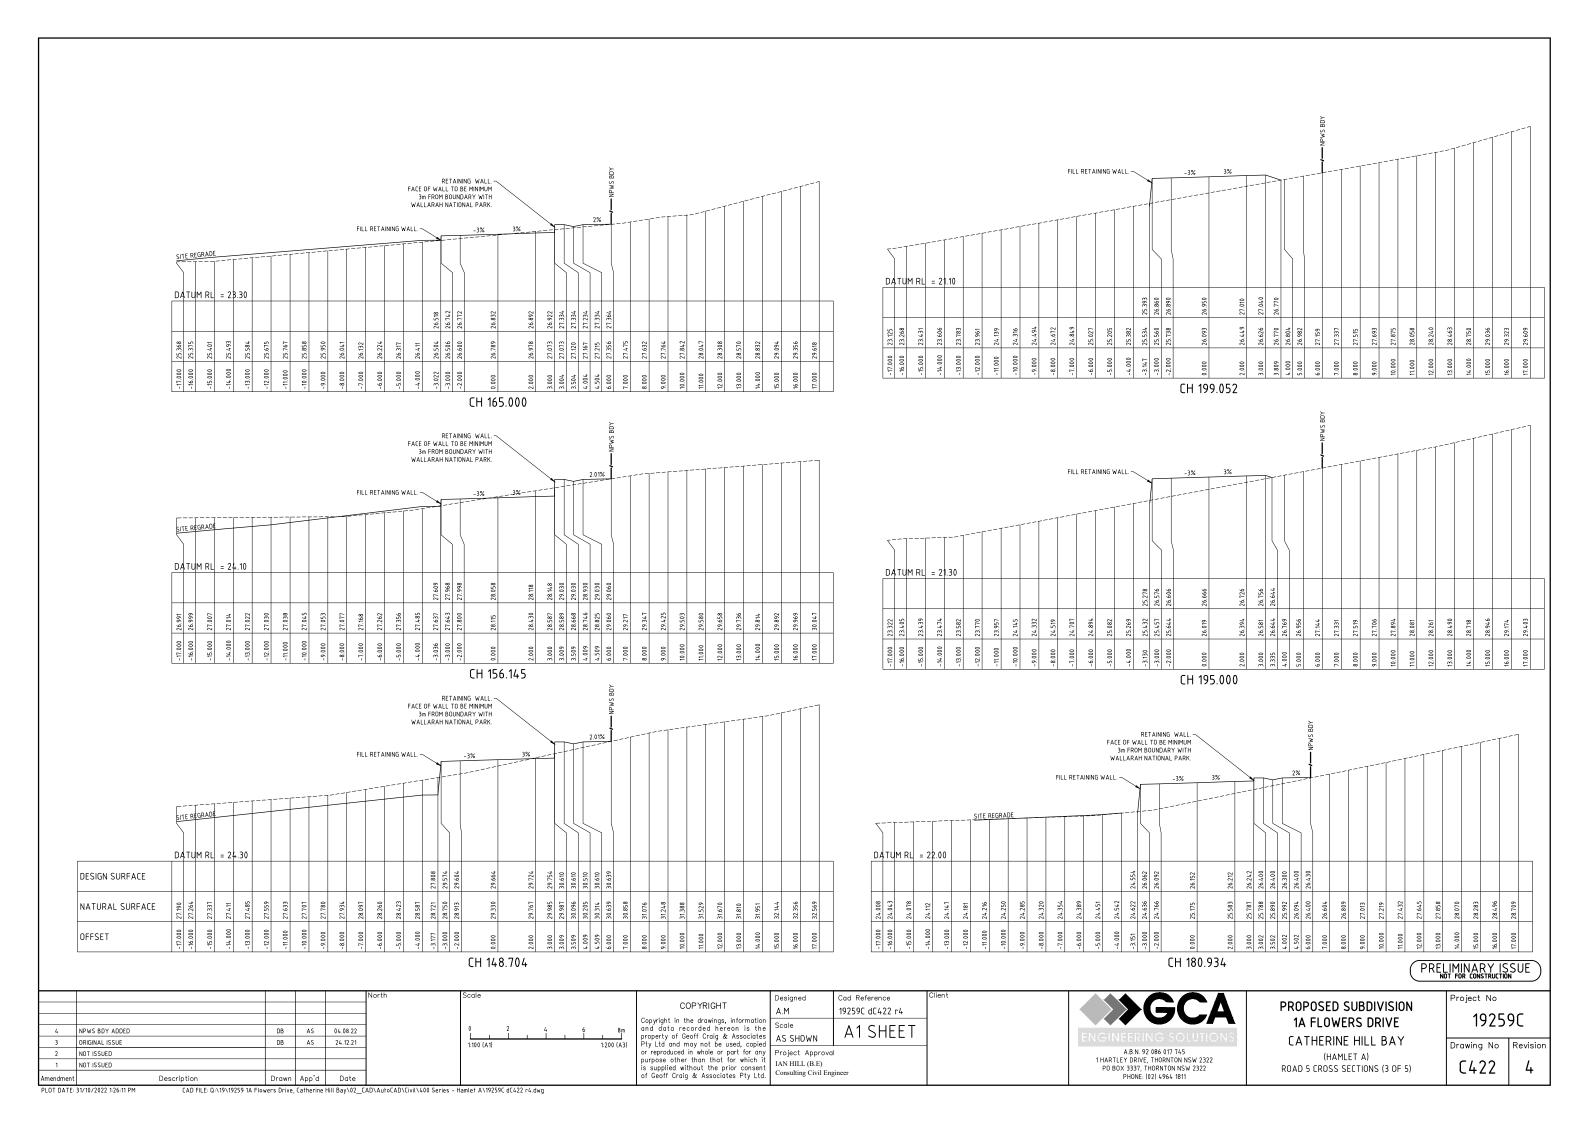
19259C


Drawing No Revision


C419 | 3





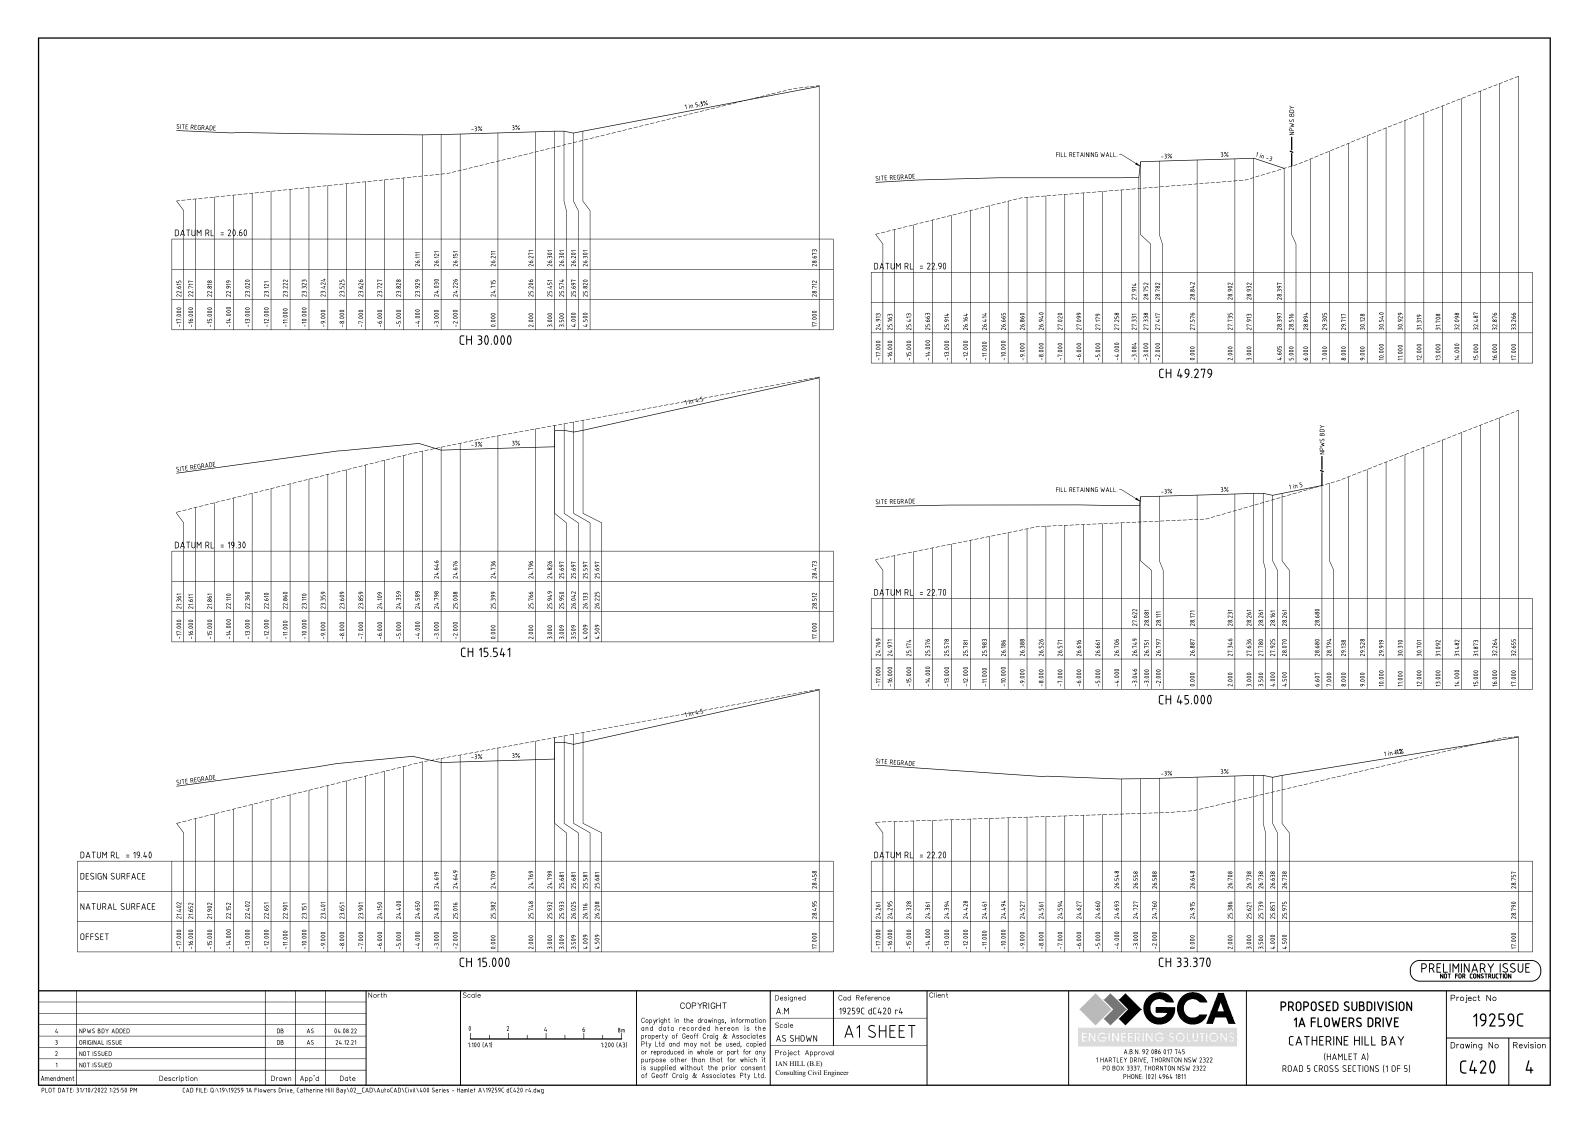

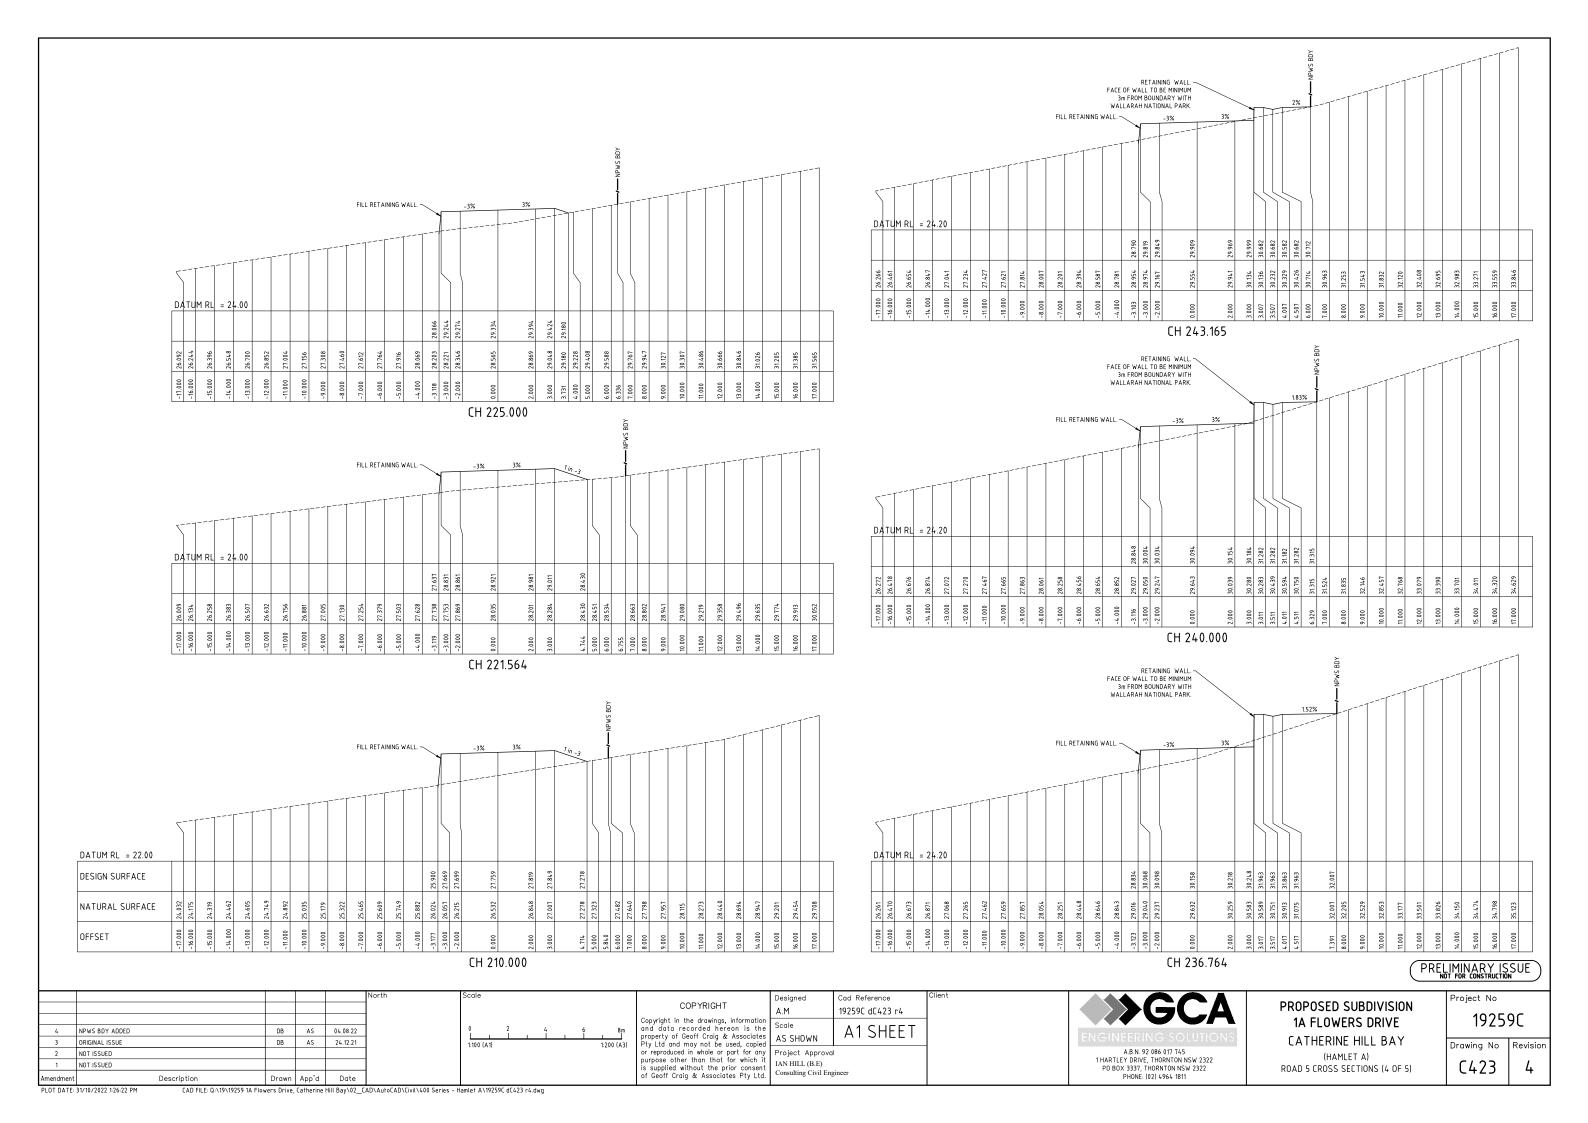

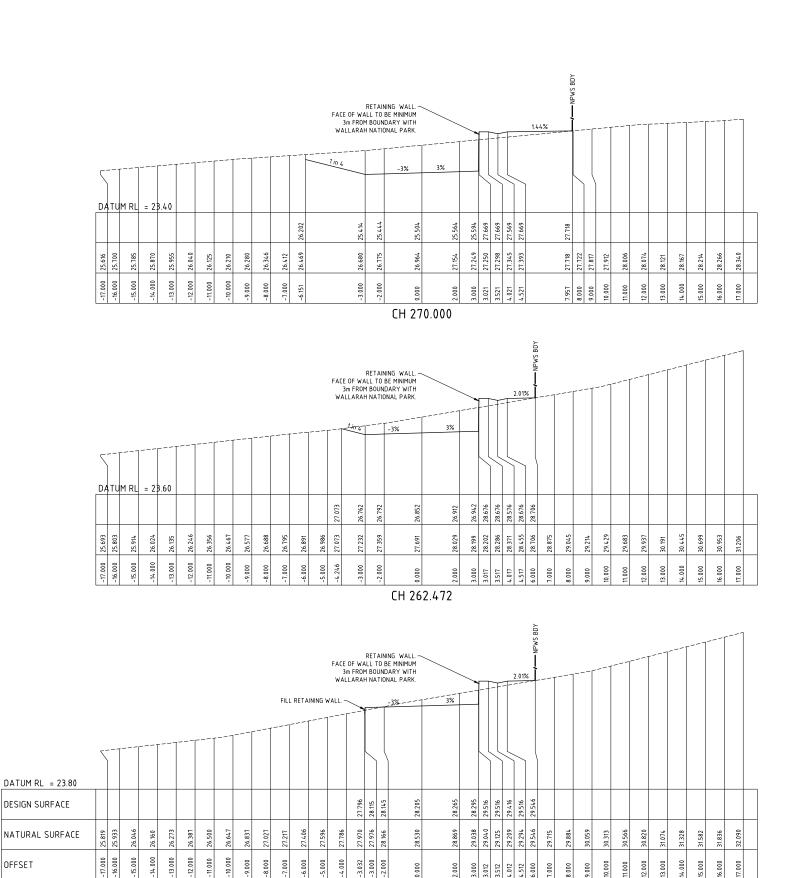

CH 255.000

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A1 SHEET AS SHOWN Project Approval IAN HILL (B.E)

Consulting Civil Engineer



PHONE: (02) 4964 1811

1A FLOWERS DRIVE CATHERINE HILL BAY (HAMLET A) ROAD 5 CROSS SECTIONS (5 OF 5)

PROPOSED SUBDIVISION

19259C Drawing No

PRELIMINARY ISSUE

Project No

Revision C424

DB

AS 04.08.22

AS 24.12.21

OFFSET


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ORIGINAL ISSUE


NOT ISSUED

NOT ISSUED





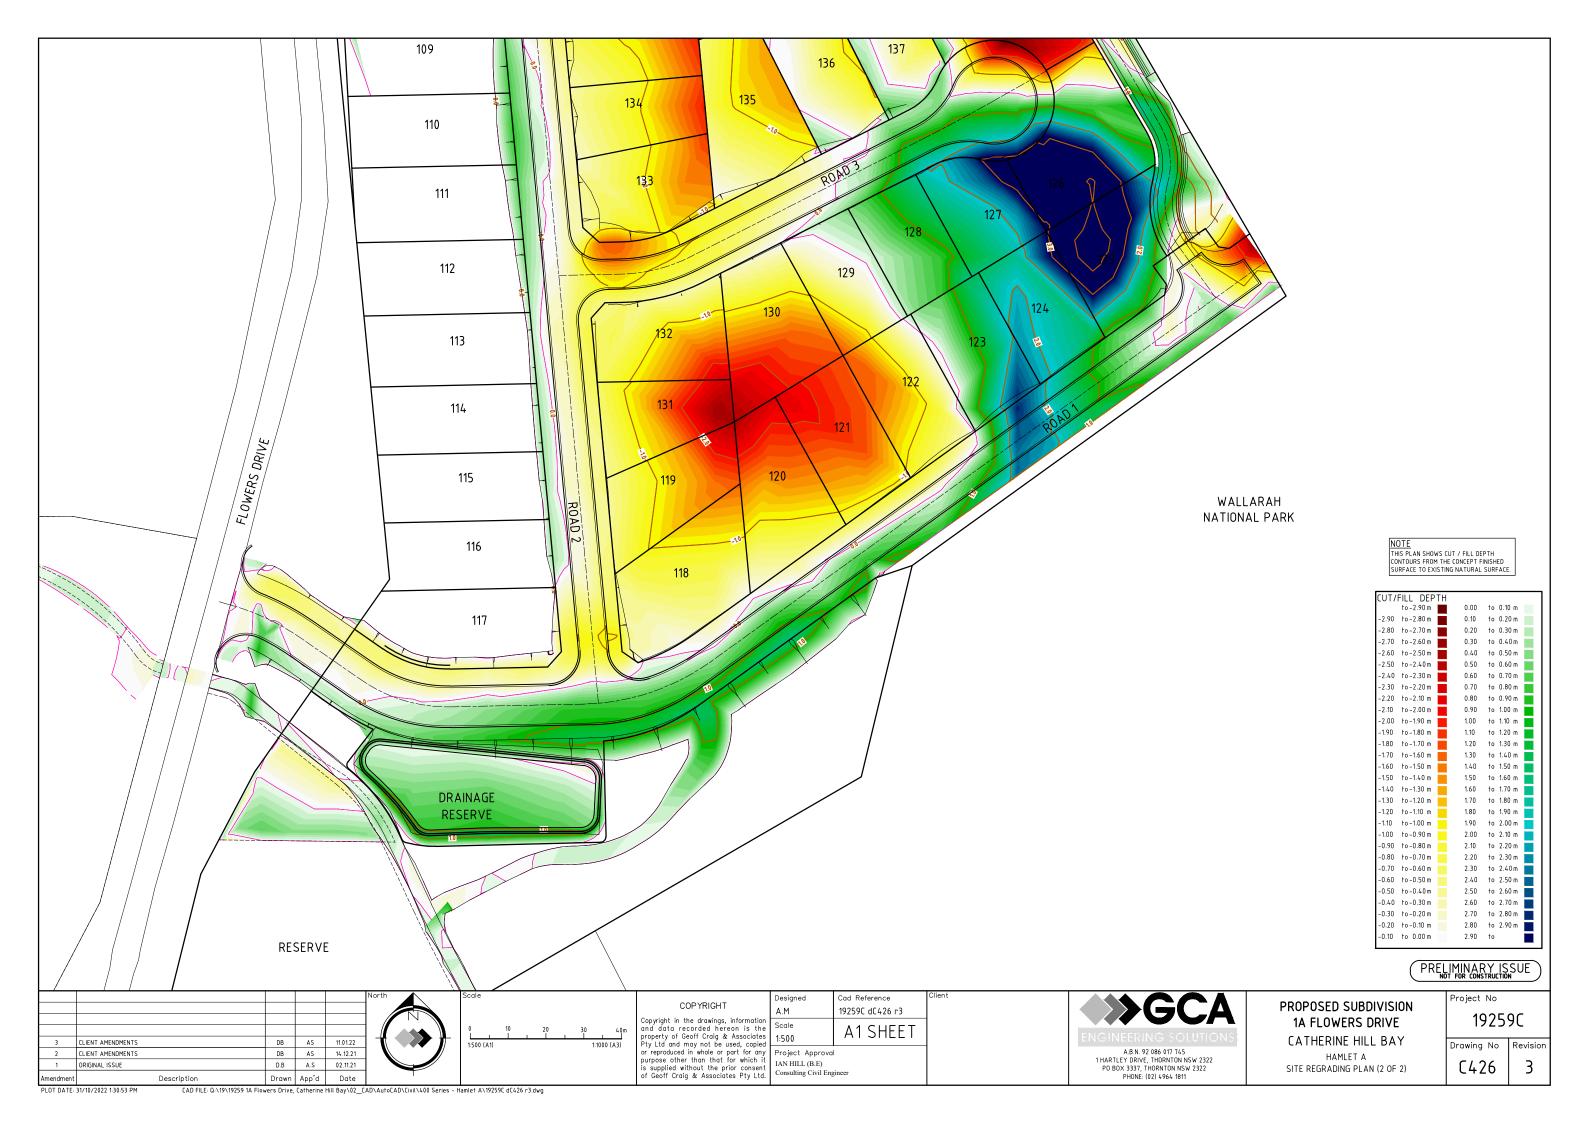

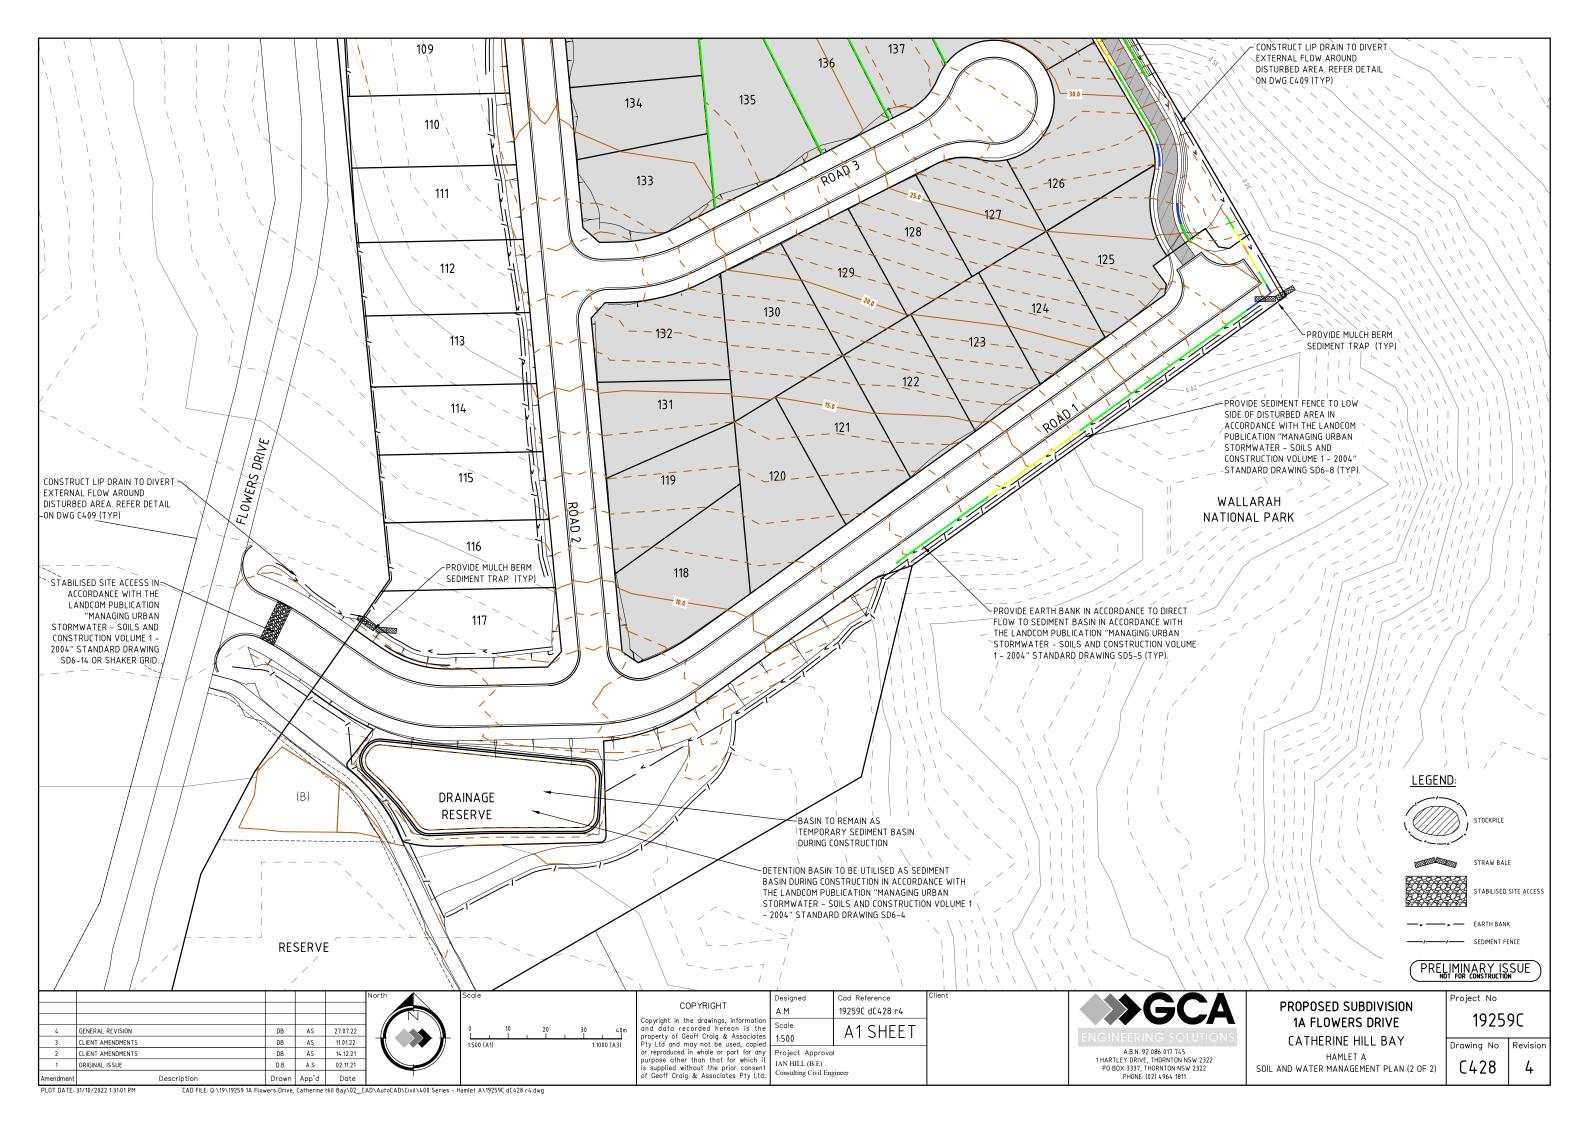

Do your part to help protect our waterways and environment Install and maintain your erosion and sediment controls 1200mm For more information on this project, please contact: LAKE 900mm

SIGN SPECIFICATIONS

FULL-COLOUR DICITAL PRINT APPLIED TO 990X1209AM ALUPANEL SHEET.

SOFTOM SECTION CAN BE FILLED IN WITH WHITESCARD OR PERMANENT MARKER BY PROJECT COMPANY.

COUNCIL STANDARD EROSION CONTROL SIGN DETAIL

EROSION AND SEDIMENT CONTROL NOTES:

THE FOLLOWING NOTES MAY NOT BE RELEVANT TO EACH DEVELOPMENT

- ESCP REFERS TO EROSION AND SEDIMENT CONTROL PLAN AND SWMP REFERS TO SOIL AND WATER MANAGEMENT PLAN ESC REFERS TO EROSION AND SEDIMENT CONTROL
- SEDIMENT, INCLUDES, BUT IS NOT LIMITED TO, CLAY, SILT, SAND, GRAVEL, SOIL, MUD, CEMENT, AND CERAMIC WASTE.
- ANY REFERENCE TO THE BLUE BOOK REFERS TO MANAGING URBAN STORMWATER- SOILS AND CONSTRUCTION. LANDCOM
- ANY REFERENCE TO THE IECA WHITE BOOKS(2008) REFERS TO IECA2008.BEST PRACTICE EROSION AND SEDIMENT CONTROL BOOKS 1-6. INTERNATIONAL EROSION CONTROL ASSOCIATION (AUSTRALASIA). PICTON NSW.

 ANY MATERIAL DEPOSITED IN ANY CONSERVATION AREA FROM WORKS ASSOCIATED WITH THE DEVELOPMENT SHALL BE
- REMOVED IMMEDIATELY BY MEASURES INVOLVING MINIMAL GROUND AND/OR VEGETATION DISTURBANCE AND NO MACHINERY, OR FOLLOWING DIRECTIONS BY COUNCIL AND/OR WITHIN A TIMEFRAME ADVISED BY COUNCIL.

- THE ESCP AND ITS ASSOCIATED ESC MEASURES SHALL BE CONSTANTLY MONITORED, REVIEWED, AND MODIFIED AS REQUIRED TO CORRECT DEFICIENCIES. COUNCIL HAS THE RIGHT TO DIRECT CHANGES IF, IN ITS OPINION, THE MEASURES THAT ARE PROPOSED OR HAVE BEEN INSTALLED ARE INADEQUATE TO PREVENT POLLUTION.

 PRIORTO ANY ACTIVITIES ONSITE, THE RESPONSIBLE PERSON(S) IS TO BE NOMINATED. THE RESPONSIBLE PERSON(S) SHALL BE RESPONSIBLE FOR THE ESC MEASURES ONSITE. THE NAME, ADDRESS AND 24 HOUR CONTACT DETAILS OF THE PERSON(S) SHALL BE ADVISED WITHIN 48 HOURS OF ANY CHANGES TO THE PERSON(S) IS THE PERSON(S) BEFORMED FOR SOME THE PERSON OF THE RESPONSIBLE PERSON(S) OR THEIR CONTACT DETAILS. IN WRITING.
- AT LEAST14 DAYS BEFORE THE NATURAL SURFACE IS DISTURBED IN ANY NEW STAGE. THE CONTRACTOR SHALL SUBMIT TO THE CERTIFIER, A PLAN SHOWING ESC MEASURES FOR THAT STAGE. THE DEGREE OF DESIGN DETAIL SHALL BE BASED ON THE
- UISTURBED AREA.
 AT ANY TIME, THE ESC MEASURES ONSITE SHALL BE APPROPRIATE FOR THE AREA OF DISTURBANCE AND ITS CHARACTERISTICS INCLUDING SOILS (IN ACCORDANCE WITH THOSE REQUIRED FOR THE SITE AS PER DCP).
 THE IMPLEMENTATION OF THE ESCP SHALL BE SUPERVISED BY PERSONNEL WITH APPROPRIATE QUALIFICATIONS AND/OR
- EXPERIENCE IN ESC ON CONSTRUCTION SITES.

 12. THE APPROVED ESCP SHALL BE AVAILABLE ON-SITE FOR INSPECTION BY COUNCIL OFFICERS WHILE WORK ACTIVITIES ARE
- 13. THE APPROVED ESCP SHALL BE UP TO DATE AND SHOW A TIMELINE OF INSTALLATION MAINTENANCE AND REMOVAL OF ESC
- ALL ESC MEASURES SHALL BE APPROPRIATE FOR THE SEDIMENT TYPE(S) OF THE SOILS ONSITE, IN ACCORDANCE WITH THE BLUE BOOK, IECA WHITE BOOKS OR OTHER CURRENT RECOGNISED INDUSTRY STANDARD FOR ESC FOR AUSTRALIAN
- CONDITIONS.
 ADEQUATE SITE DATA, INCLUDING SOIL DATA FROM A NATA APPROVED LABORATORY, SHALL BE OBTAINED TO ALLOW THE PREPARATION OF AN APPROPRIATE ESCP, AND ALLOW THE SELECTION, DESIGN AND SPECIFICATION OF REQUIRED ESC
- ALL WORKS SHALL BE CARRIED OUT IN ACCORDANCE WITH THE APPROVED ESCP(AS AMENDED FROM TIME TO TIME) UNLESS CIRCUMSTANCES ARISE WHERE
 - LIKCUMS TANCES ANSE WHERE: A) COMPLIANCE WITH THE ESCP WOULD INCREASE THE POTENTIAL FOR ENVIRONMENTAL HARM; OR B) CIRCUMSTANCES CHANGE DURING CONSTRUCTION AND THOSE CIRCUMSTANCES COULD NOT HAVE BEEN FORESEEN; OR C) COUNCIL DETERMINES THAT UNACCEPTABLE OFF-SITE SEDIMENTATION IS OCCURRING AS A RESULT OF A LAND-DISTURBING
 - ACTIVITY. IN FITHER CASE. THE PERSONIS)RESPONSIBLE MAY BE REQUIRED TO TAKE ADDITIONAL OR ALTERNATIVE PROTECTIVE ACTION AND OR LINDERTAKE REASONARI E RESTORATION WORKS WITHIN THE TIMEERAME SPECIFIED BY THE COLINCII
- ACTION, AND/ORD UNDERLARE REASONABLE RESIDNATION WORKS WITHIN THE INTERFARE SPECIFIED BY THE COUNCIL.
 ADDITIONAL ESC MEASURES SHALL BE IMPLEMENTED/AND A REVISED ESCP SUBMITTED FOR APPROVAL TO THE
 CERTIFIER(WITHIN FIVE BUSINESS DAYS OF ANY SUCH AMENDMENTS) IN THE EVENT THAT:
 A) THERE IS A HIGH PROBABILITY THAT SERIOUS OR MATERIAL ENVIRONMENTAL HARM MAY OCCUR AS A RESULT OF
- LEAVING THE SITE; OR
- B) THE IMPLEMENTED WORKS FAIL TO ACHIEVE COUNCIL'S WATER QUALITY OBJECTIVES SPECIFIED IN THESE CONDITIONS.
- C) SITE CONDITIONS SIGNIFICANTLY CHANGE; OR
 D) SITE INSPECTIONS INDICATE THAT THE IMPLEMENTED WORKS ARE FAILING TO ACHIEVE THE "OBJECTIVE" OF THE ESCP.
 A COPY OF ANY AMENDED ESCP SHALL BE FORWARDED TO AN APPROPRIATE COUNCIL OFFICER, WITHIN FIVE BUSINESS DAYS
 SHAVE CHEF AND ACTIVE THE AMENDMENT OF THE PROPERTY OF THE

SITE ESTABLISHMENT INCLUDING CLEARING AND MULCHING

- STITE ESTABLISHMENT INCLUDING LEARNING AND MULLHING

 19. NO LAND CLEARING SHALL BE UNDERTAKEN UNLESS PRECEDE BY THE INSTALLATION OF ADEQUATE DRAINAGE AND SEDIMENT CONTROL MEASURES, UNLESS SUCH CLEARINGIS REQUIRED FOR THE PURPOSE OF INSTALLING SUCH MEASURES, IN WHICH CASE, ONLY THE MINIMUM CLEARING REQUIRED TO INSTALL SUCH MEASURES SHALL OCCUR.

 20. BULK TREE CLEARING AND GRUBBING OF THE SITE SHALL BE IMMEDIATELY FOLLOWED BY SPECIFIED TEMPORARY EROSION CONTROL MEASURES (E.G.TEMPORARY GRASSING OR MULCHING) PRIOR TO COMMENCEMENT OF EACH STAGE OF
- CONSTRUCTION WORKS
- TREES AND VEGETATION CLEARED FROM THE SITE SHALL BE MULCHED ONSITE WITHIN 7 DAYS OF CLEARING APPROPRIATE MEASURES SHALL BE UNDERTAKEN TO CONTROL ANY DUST ORIGINATING DUE TO THE MULCHING OF

- VEGETATION ONSITE.

 23. ALL OFFICE FACILITIES AND OPERATIONAL ACTIVITIES SHALL BE LOCATED SUCH THAT ANY EFFLUENT, INCLUDING WASH-DOWN WATER, CAN BE TOTALLY CONTAINED AND TREATED WITHIN THE SITE.

 24. ALL REASONABLE AND PRACTICABLE MEASURES SHALL BE TAKEN TO ENSURE STORMWATER RUNOFF FROM ACCESS ROADS AND STABILISED ENTRY/EXIT SYSTEMS, DRAINS TO AN APPROPERIATE SEDIMENT CONTROL DEVICE.

 25. SITE EXIT POINTS SHALL BE APPROPRIATELY MANAGED TO MINIMISE THE RISK OF SEDIMENT BEING TRACKED ONTO SEALED,
- PUBLIC ROADWAYS.
- STORMWATER RUNDER FROM ACCESS ROADS AND STABILISED ENTRY/FXIT POINTS SHALL DRAIN TO AN APPROPRIATE

- 26. STORNWATER RUNOFF FROM ACCESS ROADS AND STABILISED ENTRY/EXIT POINTS SHALL DRAIN TO AN APPROPRIATE SEDIMENT CONTROL DEVICE.

 7. THE APPLICANT SHALL ENSURE AN ADEQUATE SUPPLY OF ESC, AND APPROPRIATE POLLUTION CLEAN-UP MATERIALS ARE AVAILABLE ON-SITE AT ALL TIMES.

 8. ALL TEMPORARY EARTH BANKS, FLOW DIVERSION SYSTEMS, AND SEDIMENT BASIN EMBANKMENTS SHALL BE MACHINE-COMPACTED, SEEDED AND MULCHED WITHIN TEN (10) DAYS OF FORMATION FOR THE PURPOSE OF ESTABLISHING A VEGETATIVE COVER, OR LINED APPROPRIATELY.

 29. SEDIMENT DEPOSITED OFF SITE AS A RESULT OF ON-SITE ACTIVITIES SHALL BE COLLECTED AND THE AREA CLEANED/REHABILITATE DAS SOON AS REASONABLE AND PRACTICABLE.

 30. CONCRETE WASTE AND CHEMICAL PRODUCTS, INCLUDING PETROLUM AND OIL-BASED PRODUCTS, SHALL BE PREVENTED FROM ENTERING ANY INTERNAL OR EXTERNAL WATER BODY, OR ANY EXTERNAL DRAINAGE SYSTEM, EXCLUDING THOSE ON-SITE WATER BODIES SPECIFICALLY DESIGNED TO CONTAIN AND/OR TREAT SUCH MATERIAL APPROPRIATE MEASURES SHALL BE INSTALLED TO TRAP THESE MATER BODY OR ANY EXTERNAL DRAINAGE SYSTEM, EXCLUDING THOSE SHALL BE INSTALLED TO TRAP THESE MATER BODY ON A PERVIOUS SURFACE (E.G. GRASS OR OPEN SOLI) AND IN SUCH A MANNER THAT ANY RESULT INTING SEDIMENT—LADDER NUNDEF IS PREVENTED FROM DISCHARGING INTO A GUITTER, DRAIN SUCH A MANNER THAT ANY RESULT INTING SEDIMENT—LADDER NUNDEF IS PREVENTED FROM DISCHARGING INTO A GUITTER, DRAIN
- SUCH A MANNER THAT ANY RESULTING SEDIMENT-LADEN RUNOFF IS PREVENTED FROM DISCHARGING INTO A GUTTER, DRAIN OR WATER. APPROPRIATE MEASURES SHALL BE INSTALLED TO TRAP THESE MATERIALS ONSITE. 32. NEWLY SEALED HARD-STAND AREAS (E.G.ROADS, DRIVEWAYS AND CAR PARKS)SHALL BE SWEPT THOROUGHLY AS SOON
- AS PRACTICABLE AFTER SEALING/SURFACING TO MINIMISE THE RISK OF COMPONENTS OF THE SURFACING COMPOUND
- ENTERING STORMWATER DRAINS.

 33. STOCKPILES OF ERODIBLE MATERIAL SHALL BE PROVIDED WITH AN APPROPRIATE PROTECTIVE COVER (SYNTHETIC OR ORGANICIIF THE MATERIALS ARE LIKELY TO BE STOCKPILED FOR MORE THAN 10 DAYS.

 34. STOCKPILES,TEMPORARY OR PERMANENT, SHALL NOT BE LOCATED IN AREAS IDENTIFIED AS NO-GO ZONES (INCLUDING, BUT
- NOT LIMITED TO, RESTRICTED ACCESS AREAS, BUFFER ZONES, OR AREAS OF NON-DISTURBANCE) ON THE ESCP.
- NO MORE THAN ISONO A STORMWATER, SEWER LINE OR OTHER SERVICES UR AREAS UP NUN-UIS JURBANCEJ ON THE ESCP.

 NO MORE THAN ISONOFA A STORMWATER, SEWER LINE OR OTHER SERVICE TRENCH SHALL TO BE OPEN AT ANY ONE TIME.

 SITE SPOIL SHALL BE LAWFULLY DISPOSED OF IN A MANNER THAT DOES NOT RESULT IN ONGOING SOIL EROSION OR

 ENVIRONMENTAL LALDEM.
- ENVIRONMENTAL HARM
- ENVIRONMENTAL HARM.
 WHEREVER REASONABLE AND PRACTICABLE, STORMWATER RUNOFF ENTERING THE SITE FROM EXTERNAL AREAS, AND NON-SEDIMENT LADEN (CLEAN) STORMWATER RUNOFF ENTERING A WORK AREA OR AREA OF SOIL DISTURBANCE, SHALL BE DIVERTED AROUND OR THROUGH THAT AREA IN A MANNER THAT MINIMISES SOIL EROSION AND THE CONTAMINATION OF THAT WATER FOR ALL DISCHARGES UP TO THE SPECIFIED DESIGN STORM DISCHARGE

SITE MANAGEMENT INCLUDING DUST

- TE FIARMAGEMENT INCLUDING DOS!

 PRIORITY SHALL BE GIVEN TO THE PREVENTION, OR AT LEAST THE MINIMISATION, OF SOIL EROSION, RATHER THAN THE TRAPPING OF DISPLACED SEDIMENT. SUCH A CLAUSE SHALL NOT REDUCE THE RESPONSIBILITY TO APPLY AND MAINTAIN, AT ALL TIMES, ALL NECESSARY ESC MEASURES.

 MEASURES USED TO CONTROL WIND EROSION SHALL BE APPROPRIATE FOR THE LOCATION AND PREVENT SOIL EROSION AND EMISSIONS FROM SITE AT ALL TIMES, INCLUDING WORKING HOURS, OUT OF HOURS, WEEKENDS, PUBLIC HOLIDAYS, AND DURING ANY OTHER CHUTDOWN DEPORTS.
- ANY OTHER SHUTDOWN PERIODS.

 40. THE APPLICATION OF LIQUID OR CHEMICAL-BASED DUST SUPPRESSION MEASURES SHALL ENSURE THAT SEDIMENT-LADEN
- 4.0 THE APPLICATION OF LIQUID OR CHEMICAL-BASED DUST SUPPRESSION MEASURES SHALL ENSURE THAT SEDIMENT-LADEN RUNDER FESULTING FROM SUCH MEASURES DOES NOT CREATE A TRAFFIC OR ENVIRONMENTAL HAD MADE.

 4.1 ALL CUT AND FILL EARTH BATTERS LESS THAN 3M IN ELEVATION SHALL BE TOPSOILED, AND GRASS SEEDED/HYDROMULCHED WITHIN 10 DAYS OF COMPLETION OF GRADING IN CONSULTATION WITH COUNCIL.

 4.2. ALL DISTURBED AREAS SHALL BE STABILISED IN ACCORDANCE WITH TIMELINES IN THE BLUE BOOK.

 4.3. ALL REASONABLE AND PRACTICABLE MEASURES SHALL BE TAKEN TO PREVENTIOR AT LEAST MINIMISE, THE RELEASE OF SEDIMENT FROM THE STITE.

 4.4. SUITABLE ALL-WEATHER MAINTENANCE ACCESS SHALL BE PROVIDED TO ALL SEDIMENT CONTROL DEVICES.

 4.5. SEDIMENT CONTROL DEVICES OTHER THAN SEDIMENT BASINS SHALL BE PRESIDE THE AND MADE FULLY YPPRATIONAL AS SOON.

- SUITABLE ALL-WEATHER MAINTENANCE ACCESS SHALL BE PROVIDED TO ALL SEDIMENT CONTROL DEVICES.
 SEDIMENT CONTROL DEVICES, OTHER THAN SEDIMENT BASINS, SHALL BE DE-SILTED AND MADE FULLY OPERATIONAL AS SOON AS REASONABLE AND PRACTICABLE AFTER A SEDIMENT-PRODUCING EVENT, WHETHER NATURAL OR ARTIFICIAL, IF THE DEVICE'S SEDIMENT RETENTION CAPACITY FALLS BELOW 75% OF ITS DESIGN RETENTION CAPACITY.
 ALL EROSION AND SEDIMENT CONTROL MEASURES, INCLUDING DEARNAGE CONTROL MEASURES, SHALL BE MAINTAINED IN PROPER WORKING ORDER AT ALL TIMES DURING THEIR OPERATIONAL LIVES.
 WASHING/FLUSHING OF SEALED ROADWAYS SHALL ONLY OCCUR WHERE SWEEPING HAS FAILED TO REMOVE SUFFICIENT SEDIMENT AND THERE IS A COMPELLION NEED TO REMOVE THE REMAINING SEDIMENT ICE, FOR SAFETY REASONS), IN SUCH CIRCUMSTANCES, ALL REASONABLE AND PRACTICABLE SEDIMENT CONTROL MEASURES SHALL BE USED TO PREVENT OR AT LEAST MINIMISE, THE RELEASE OF SEDIMENT TOR RECIVING WAATERS. ONLY THOSE MEASURES THAT WILL NOT CAUSE SAFETY AND PROPERTY FLODDING ISSUES SHALL BE EMPLOYED. SEDIMENT REMOVED FROM ROADWAYS SHALL BE DISPOSED OF IN A LAWFUL MANNER THAT DOES NOT CAUSE ONGOING SOIL EROSION OR ENVIRONMENTAL HARM.
 SEDIMENT REMOVED FROM SEDIMENT TRAPS AND PLACES OF SEDIMENT TEROSION ON SHOURD SHALD HARM.
 SEDIMENT REMOVED FROM SEDIMENT TRAPS AND PLACES OF SEDIMENT DEPOSITION SHALL BE DESORDED OF IN A LAWFUL
- 48. SEDIMENT REMOVED FROM SEDIMENT TRAPS AND PLACES OF SEDIMENT DEPOSITION SHALL BE DISPOSED OF IN A LAWFUL MANNER THAT DOES NOT CAUSE ONGOING SOIL EROSION OR ENVIRONMENTAL HA

SEDIMENT BASINS - INSTALLATION, MAINTENANCE AND REMOVAL INCLUDING SEDIMENT TRAPS

- 49. AS-CONSTRUCTED PLANS SHALL BE PREPARED FOR ALL CONSTRUCTED SEDIMENT BASINS AND ASSOCIATED EMERGENCY SPILLWAYS. SUCH PLANS SHALL VERIFY THE BASIN'S DIMENSIONS, LEVELS AND VOLUMES COMPLY WITH THE APPROVED DESIGN DRAWINGS. THESE PLANS MAY BE REQUESTED BY THE CERTIFIER OR COUNCIL.

 50. SEDIMENT BASINS SHALL BE CONSTRUCTED AND FULLY OPERATIONAL PRIOR TO ANY OTHER SOIL DISTURBANCE IN THEIR
- 51 INSTALL AN INTERNAL GATED VALVE OR SIMILAR IN ANY OUTLET PIPE ONCE PIPES INSTALLED OR INSTALL A SACRIFICIAL PIPE FROM BASIN THROUGH WALL TO EXTERNAL OUTLET POINT. THE VALVE SHALL BE CONNECTED TO A RISER MADE FROM SLOTTED PIPE IN THE BASIN. THE VALVE MAY BE OPENED ONCE CAPTURED WATER MEETS WATER QUALITY REQUIREMENTS. THE FINAL SETUP FOR TEMPORARY INTERNAL OUTLET STRUCTURES TO BE CONNECTED TO CONSTRUCTION WITH COUNCIL. THIS SETUP WILL ENABLE DISCHARGE OF TREATED WATER FROM SITE WITHOUT NEED FOR
- 52. A SEDIMENT STORAGE LEVEL MARKER POST SHALL BE WITH A CROSS MEMBER SET JUST BELOW THE TOP OF THE SEDIMENT STORAGE ZONE (AS SPECIFIED ON THE APPROVED ESCP). AT LEAST A 75mm WIDE POST SHALL BE FIRMLY SET INTO THE
- THE SITE MANAGER SHALL OBTAIN THE RELEVANT APPROVALS FROM THE RELEVANT ORGANISATIONS TO DISCHARGE TREATED WATER FROM ANY EXISTING BASINS, ORGANISATIONS MAY INCLUDE, BUT NOT BE LIEVANT ORGANISATIONS TO DISCINED THE WATER, AND COUNCIL.

 54. WHERE MORE THAN ONE STAGE IS TO BE DEVELOPED AT ONETIME, OR BEFORE THE PRECEDING STAGE IS COMPLETE, THE SEDIMENT BASINIS) FOR THESE STAGES SHALL HAVE SUFFICIENT CAPACITY TO CATER FOR ALL AREA DIRECTED TO THE
- 55. PRIOR TO ANY FORECAST WEATHER EVENT LIKELY TO RESULT IN RUNGEE ANY BASINS/TRAPS SHALL BE DEWATERED TO
- 55. PRIOR TO ANY FORECAST WEATHER EVENT LIKELY TO RESULT IN RUNDEF, ANY BASINS/TRAPS SHALL BE DEWATERED TO PROVIDE SUFFICIENT CAPACITY TO CAPTURE SEDIMENT LADEN WATER FROM THE SITE.

 56. SUFFICIENT DUANTITIES OF CHEMICALS/AGENTS TO TREAT CAPTURED WATER SHALL BE PLACED SUCH THAT WATER ENTERING THE BASIN MIXES WITH THE CHEMICAL/AGENTS AND IS CARRIED INTO THE BASIN TO SPEED UP CLARIFICATION.

 57. ANY BASIN SHALL BE DEWATERED WITHIN THE X-DAY RAINFALL DEPTH USED TO CALCULATE THE CAPACITY OF THE BASIN, AFTER A RAINFALL EVENT.

 58. SUFFICIENT DUANTITIES OF CHEMICALS/AGENTS TO TREAT TURBID WATER SHALL BE SECURELY STORED ON-SITE TO PROVIDE FOR AT LEAST THREE COMPLETE TREATMENTS OF ALL BASINS REQUIRING CHEMICALLY TREATMENT ONSITE.

 59. DRIVED TO THE CONTYDULED DISCHAGESEE OF WATERING ACTIVITIES ENDING SITE INCLUDING SYMMOLOGY.
- 59. PRIOR TO THE CONTROLLED DISCHARGE(E.G. DE-WATERING ACTIVITIES) FROM SITE INCLUDING EXCAVATIONS AND/OR SEDIMENT BASINS. THE FOLLOWING WATER QUALITY OBJECTIVES SHALL BE ACHIEVED:
- SEUMENT BASINS, THE FULLOWING WATER QUALITY DISECTIVES SHALL BE ALTHEVED:
 A) TOTAL SUSPENDED SOLIDS (TSS) TO A MAXIMUM SO MILLIGRAMS/L;
 B) WATER PH BETWEEN 6.5 AND 8.5, UNLESS OTHERWISE REQUIRED BY THE COUNCIL;
 () TURBIDITY (MEASURED IN TIUS) TO A MAXIMUM OF 60 NTU); AND
 D) EC LEVELS NO GREATER THAN BACKGROUND LEVELS.
 60. THE DEVELOPMENT APPROVAL MAY REQUIRE TESTING OF ADDITIONAL WATER QUALITY ELEMENTS PRIOR TO DISCHARGE.E.G.
- INCLUDING BUT NOT LIMITED TO METALS, ORGANIC SUBSTANCES, CHEMICALS OR BACTERIOLOGICAL INDICATORS. 61.
 61. A SAMPLE OF THE RELEASED TREATED WATER SHALL BE KEPT ONSITE IN A CLEAR CONTAINER WITH THE SAMPLE DATE
- 62. WATER QUALITY SAMPLES SHALL BE TAKEN AT A DEPTH NO LESS THAN 200MM BELOW THE WATER SURFACE OF THE

- 62. WATER QUALITY SAMPLES SHALL BE TAKEN AT A DEPTH NO LESS THAN 200MM BELOW THE WATER SURFACE OF THE BASIN.

 8. NO ALUMINIUM BASED PRODUCTS MAY BE USED TREAT CAPTURED WATER ONSITE WITHOUT THE PRIOR WRITTEN PERMISSION FROM AN APPROPRIATE COUNCIL OFFICER. THE APPLICANT SHALL HAVE A DEMONSTRATED ABILITY TO USE SUCH PRODUCTS CORRECTLY AND WITHOUT ENVIRONMENTAL HARM PRIOR TO ANY APPROVAL.

 84. THE CHEMICAL/AGENT USED IN TYPE D AND TYPE F BASINS TO TREAT CAPTURED WATER CAPTURED IN THE BASIN SHALL BE APPLIED IN CONCENTRATIONS SUFFICIENT TO ACHIEVE COUNCIL'S WATER QUALITY OBJECTIVES WITHIN THE X-DAY RAINFALL EVENT.

 85. ALL MANUFACTURERS' INSTRUCTIONS SHALL BE FOLLOWED FOR ANY CHEMICALS/AGENTS USED ONSITE, EXCEPT WHERE APPROVED BY THE RESPONSIBLE PERSON OR AN APPROPRIATE COUNCIL OFFICER.

 86. THE APPLICANT SHALL ENSURE THAT ON EACH OCCASION A TYPE F OR TYPE D BASIN WAS NOT DE-WATERED PRIOR TO BEING SURCHARGED BY A FOLLOWING RAINFALL EVENT, A REPORT IS PRESENTED TO AN APPROPRIATE COUNCIL OFFICER WITHIN S DAYS IDENTIFYING THE CIRCUMSTANCES AND PROPOSED AMENDMENTS, IF ANY, TO THE BASIN'S OPERATING PROCEDURES.
- 67. SETTLED SEDIMENT SHALL BE REMOVED AS SOON AS REASONABLE AND PRACTICABLE FROM ANY SEDIMENT BASIN IF: A) IT IS ANTICIPATED THAT THE NEXT STORM EVENT IS LIKELY TO CAUSE SEDIMENT TO SETTLE ABOVE THE BASIN'S
- SEDIMENT STORAGE ZONE: OR
- B) THE ELEVATION OF SETTLED SEDIMENT IS ABOVE THE TOP OF THE BASIN'S SEDIMENT STORAGE ZONE, OR

 () THE ELEVATION OF SETTLED SEDIMENT IS ABOVE THE BASINS SEDIMENT MARKER LINE.

 SCOUR PROTECTION MEASURES PLACED ON SEDIMENT BASINS SEDIMENT MARKER LINE.

 SPILLWAY CHUTE AND ITS SIDE BATTERS FROM SCOUR, AND SHALL EXTEND A MINIMUM OF 3m BEYOND THE DOWNSTREAM
- 69. SUITABLE ALL-WEATHER MAINTENANCE ACCESS SHALL BE PROVIDED TO ALL SEDIMENT CONTROL DEVICES.
- MATERIALS WHETHER LIQUID OR SOLID REMOVED FROM ANY ESC MEASURE OR EXCAVATION DURING MAINTENANCE OF DECOMMISSIONING, SHALL BE DISPOSED OF IN A MANNER THAT DOES NOT CAUSE ONGOING SOIL EROSION, WATER POLLUTION OR ENVIRONMENTAL HARM.
- OR ENVIRONMENTAL HARM.

 1. ALL SEDIMENT BASINS SHALL REMAIN FULLY OPERATIONAL AT ALL TIMES UNTIL THE BASIN'S DESIGN CATCHMENT ACHIEVES

 70% GROUND COVER OR SURFACE STABILISATION ACCEPTABLE TO COUNCIL.

 72. THE ESC MEASURES INSTALLED DURING THE DECOMMISSIONING AND REHABILITATION OF A SEDIMENT BASIN SHALL COMPLY

 WITH SAMM STANDARDS SPECIFIED FOR THE NORMAL CONSTRUCTION WORKS.

 73. A SEDIMENT BASIN SHALL NOT BE DECOMMISSIONED UNTIL ALL UP-SLOPE SITE STABILISATION MEASURES HAVE BEEN

 IMPLEMENTED AND ARE APPROPRIATELY WORKING TO CONTROL SOIL EROSION AND SEDIMENT RUN

 74. IMMEDIATELY PRIOR TO THE CONSTRUCTION OF THE PERMANENT STORMWATER TREATMENT DEVICE, APPROPRIATE FLOW

 PROPERS CONDITIONS CHALL BE SETABLISHED TO DEVICE A POPER STATEMENT OF THE PERMANENT.
- BYPASS CONDITIONS SHALL BE ESTABLISHED TO PREVENT SEDIMENT-LADEN WATER ENTERING THE DEVICE

REVEGETATION/STABILISATION

- TEMPORARY STABILISATION MAY BE ATTAINED USING VEGETATION NON REWETTABLE SOIL POLYMERS. OR PNEUMATICALLY
- APPLIED ENGINE CONTROLS.

 76. ALL CUT AND FILL EARTH BATTERS LESS THAN 3M IN ELEVATION SHALL BE TOPSOILED, AND GRASS SEEDED/HYDROMULCHED WITHIN 10 DAYS OF COMPLETION OF GRADING IN CONSULTATION WITH COUNCIL.

 77. AT THE COMPLETION OF FORMATION IN ANY SECTION, ALL DISTURBED AREAS SHALL BE STABILISED IN ACCORDANCE WITH
- TIME LINES IN THE BLUE BOOK.
 THE LMCC SEED MIX SHALL BE USED UNLESS STATED ON THE ESCP/SWMP
- 79. THE PH LEVEL OF TOPSOIL SHALL BE APPROPRIATE TO ENABLE ESTABLISHMENT AND GROWTH OF SPECIFIED VEGETATION PRIOR TO INITIATING THE ESTABLISHMENT OF VEGETATION.
- 80. NON REWETTABLE BINDER SHALL BE USED IN ALL HYDROMULCH/HYDROSEED/POLYMER MIXES ON SLOPES OR WORKS

- NON REWETTABLE BINDER SHALL BE USED IN ALL HYDROMULCH/HYDROSEED/POLYMER MIXES ON SLOPES OR WORKS
 ADJACENT TO A WATER COURSE.
 SOIL AMELIORANTS SHALL BE ADDED TO THE SOIL IN ACCORDANCE WITHAN APPROVED LANDSCAPE PLAN, VEGETATION
 MANAGEMENT PLAN, AND/OR SOIL ANALYSIS.
 SURFACE SOIL DENSITY, COMPACTION AND SURFACE ROUGHNESS SHALLBE ADJUSTED PRIOR TO SEEDING/PLANTING IN
 ACCORDANCE WITH AN APPROVED LANDSCAPE PLAN, VEGETATION MANAGEMENT PLAN, AND/OR SOIL ANALYSIS.
 PROCEDURES FOR INITIATING A SITE SHUTDOWN, WHETHER PROGRAMMED OR UN-PROGRAMSPICAL INCORPORATE
 REVEGETATION OF ALL SOIL DISTURBANCES UNLESS OTHERWISE APPROVEDBY COUNCIL. THE STABILISATION WORKS SHALL
 NOT DELY JURDA THE LONGENITY OF BOON VEGETATEDROSING CONTROL BLANGET FOR TEMPORA COULD BUNDERS. NOT RELY UPON THE LONGEVITY OF NON-VEGETATEDEROSION CONTROL BLANKETS, OR TEMPORARY SOIL BINDERS

SITE MONITORING AND MAINTENANCE

- 481. THE APPLICANT SHALL ENSURE THAT APPROPRIATE PROCEDURES AND SUITABLY QUALIFIED PERSONNEL ARE ENGAGED TO
 PLAN AND CONDUCT SITE INSPECTIONS AND WATER QUALITY MONITORING THROUGHOUT THE CONSTRUCTION AND MAINTENANCE PHASE.
- 85 85 ALL ESC MEASURES SHALL BE INSPECTED AND ANY MAINTENANCE LINDERTAKEN IMMEDIATELY:

AND THE AVERAGE RESULT USED TO DETERMINE QUALITY

- 85. 85. ALL ESC MEASURES SHALL BE INSPECTED AND ANY MAINTENANCE UNDERTAKEN IMMEDIATELY:

 A) AT LEAST DAILY (WHEN WORK IS NOT OCCURRING ON-SITE); AND

 B) AT LEAST WEEKLY (WHEN WORK IS NOT OCCURRING ON-SITE); AND


 C) WITHIN 24HRS OF EXPECTED RAINFALL; AND

 D) WITHIN 18HRS OF A RAINFALL EVENT THAT CAUSES RUNOFF ON THE SITE.

 86. WRITTEN RECORDS SHALL BE KEPT ONSITE OF ESC MONITORING AND MAINTENANCE ACTIVITIES CONDUCTED DURING THE CONSTRUCTION AND MAINTENANCE PERIODS, AND BE AVAIL ABLE TO COUNCIL OFFICERS ON REQUEST.
- 87. ALL ENVIRONMENTALLY RELEVANT INCIDENTS SHALL BE RECORDED IN A FIELD LOG THAT SHALL REMAIN ACCESSIBLE TO
- ALL RELEVANT REGULATORY AUTHORITIES.
 ALL WATER QUALITY DATA, INCLUDING DATES OF RAINFALL, DATES OF TESTING, TESTING RESULTS AND DATES OF WATER RELEASE, SHALL BE KEPT IN AN ON-SITE FEGISTER. THE REGISTER IS TO BE MAINTAINED UP TO DATE FOR THE DURATION OF THE APPROVED WORKS AND BE AVAILABLE ON-SITE FOR INSPECTION BY ALL RELEVANT REGULATORY AUTHORITIES ON
- 89. AT NOMINATED INSTREAM WATER MONITORING SITES, A MINIMUM OF 3 WATER SAMPLES SHALL BE TAKEN AND ANALYSED,

INSTREAM WORKS

90. ALL INSTREAM WORKS (INCLUDING IN OR ADJACENT TO WATERCOURSES NATURAL OR MANMADE, FLOWING OR NOT) SHALL BE CARRIED OUT IN ACCORDANCE WITH THE IECA WHITE BOOKS

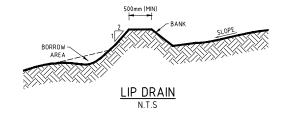

REFER TO DWG SK215-SK216 FOR LANDCOM BLUE BOOK EROSION AND SEDIMENT STANDARD DRAWINGS

TYPICAL CONSTRUCTION SCHEDULE

		WEEK							
	1	2	3	4	5	6	7	8	
CONSTRUCT ALL TEMPORARY SEDIMENT BASINS									
PLACE SILT FENCE ALONG ROAD BOUNDARIES AS SHOWN									
PLACE SILT FENCE BELOW AREAS TO BE REGRADED									
CONSTRUCT ALL DIVERSION BANKS CATCHING CLEAN WATER									
ROAD CONSTRUCTION AND REGRADING									
PLACE SILT FENCE AROUND TOPSOIL STOCKPILES									
PLACE SEDIMENT BARRIERS AROUND STORMWATER PITS AT COMPLETION OF DRAINAGE									
PLACE STRIP TURF PARALLEL TO DESIGN CONTOURS ALONG ROAD AS SHOWN									

PRELIMINARY ISSUE

Project No

LIENT AMENDMENTS DB AS 11.01.22 CLIENT COMMENTS DB AS 17.12.21 NOT ISSUED

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Designed Cad Reference A.M 19259C dC429 r3 A1 SHEET Project Approval

IAN HILL (B.E)

Consulting Civil Engineer

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PROPOSED SUBDIVISION 1A FLOWERS DRIVE CATHERINE HILL BAY


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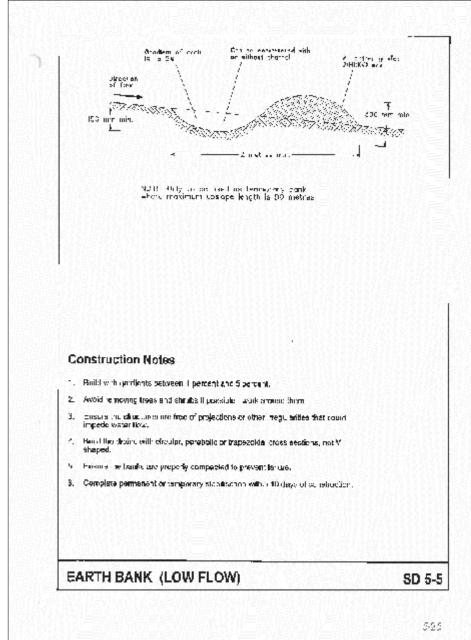
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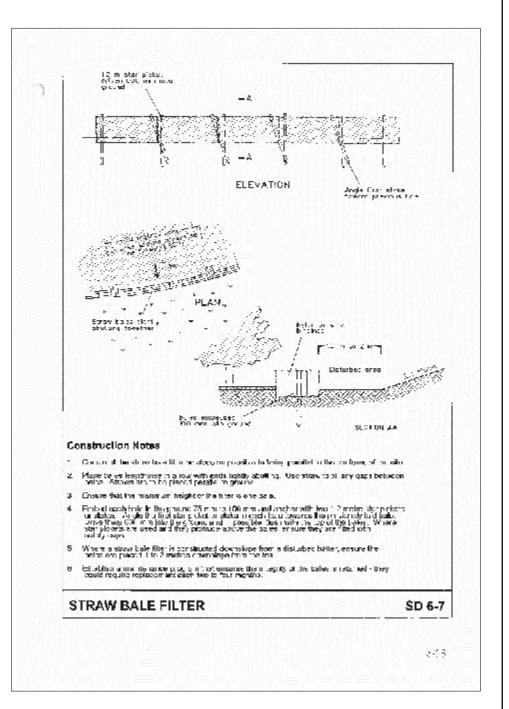
Revision

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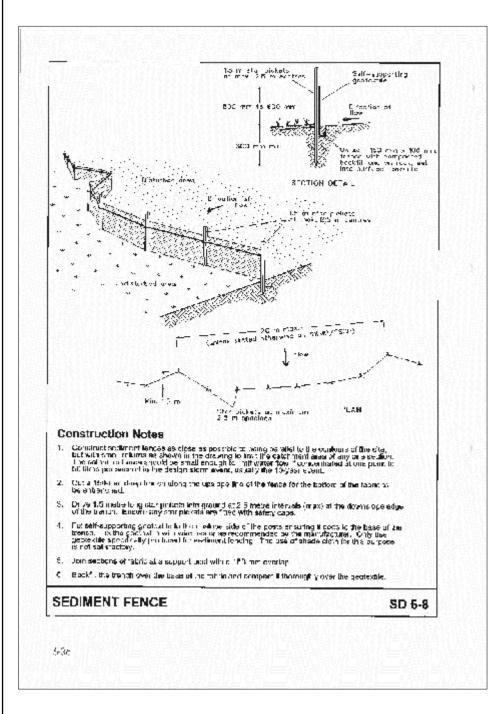
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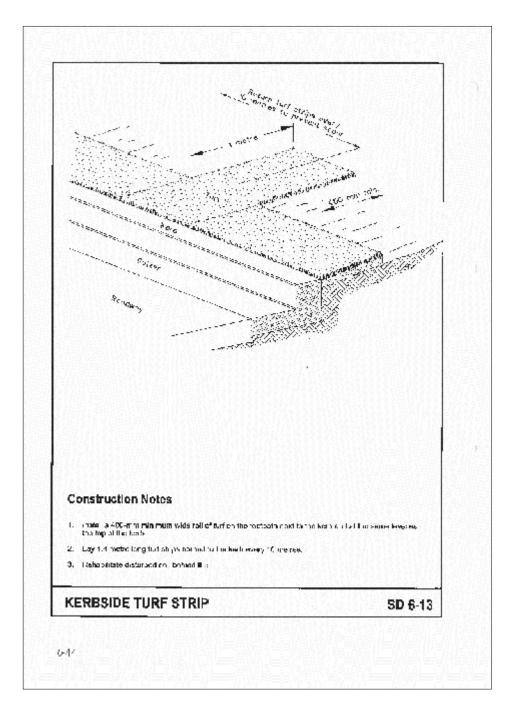







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					North	Scale	COPYRIGHT	Designed A.M	Cad Reference 19259C dC430 r3	Client	→>GCA	PROPOSED SUBDIVISION	Project No	
							Copyright in the drawings, information and data recorded hereon is the property of Geoff Craig & Associates	Scale	A1 SHEET		ENGINEERING SOLUTIONS	1A FLOWERS DRIVE	1925	90
2	CLIENT AMENDMENTS CLIENT COMMENTS	DB DB	AS AS	11.01.22 17.12.21			Pty Ltd and may not be used, copied or reproduced in whole or part for any purpose other than that for which it	Project Approve			A.B.N. 92 086 017 745 1 HARTLEY DRIVE, THORNTON NSW 2322	CATHERINE HILL BAY HAMLET A	Drawing No	
1 Amendme	NOT ISSUED Ont Description	Drawn	App'd	Date	-		is supplied without the prior consent of Geoff Craig & Associates Pty Ltd.	IAN HILL (B.E) Consulting Civil En	gineer		PO BOX 3337, THORNTON NSW 2322 PHONE: (02) 4964 1811	LANDCOM BLUE BOOK FIGURES (1 OF 2)	C430	3

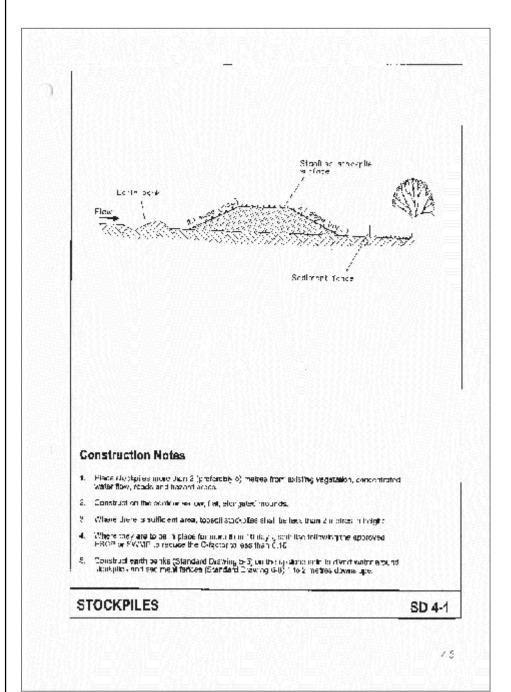



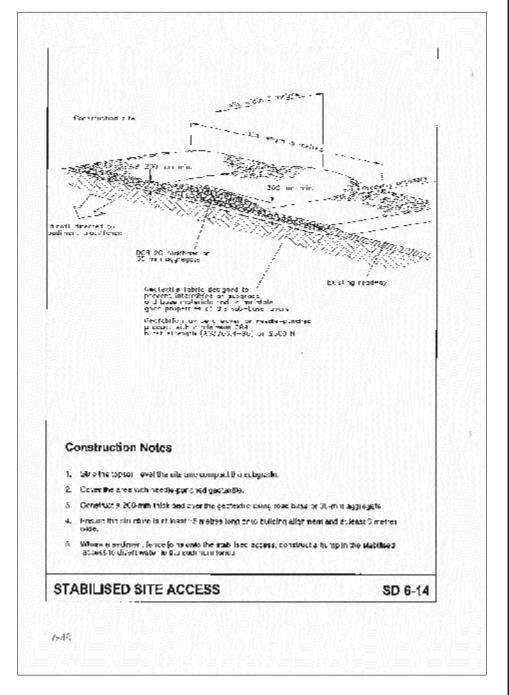

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Cad Reference 19259C dC431 r3 A1 SHEET

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1A FLOWERS DRIVE CATHERINE HILL BAY HAMLET A LANDCOM BLUE BOOK FIGURES (2 OF 2)

PROPOSED SUBDIVISION

Project No 19259C

Drawing No C431

Revision